Project Description


5760 LUCAS VALLEY RD. NICASIO, CA 94946

Project Description

(N) SINGLE FAMILY RESIDENCE ON A PREVIOUSLY UNDEVELOPED SITE. THE RESIDENCE TO CONSIST OF THE MAIN HOUSE CONNECTED TO A GARAGE /ARTIST STUDIO WITH A CONDITIONED ENTRY FOYER BUILDING.

*AN AUTOMATIC FIRE SPRINKLER SYSTEM - NFPA 13R (4 SPRINKLER HEADS FLOWING) WITH FDC (A 2 -1/2" MALE NST CONNECTION) SHALL BE UNDER SEPARATE PERMIT *POOL UNDER SEPARATE PERMIT

Project Vicinity Map

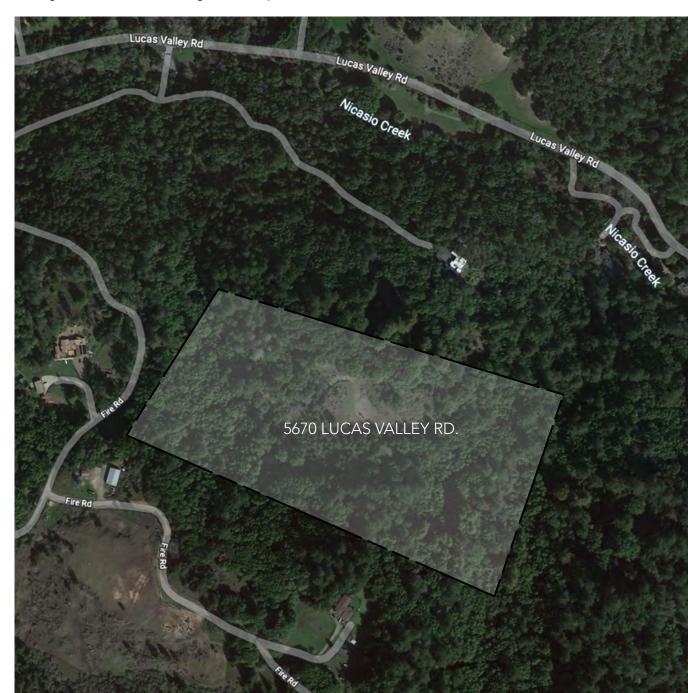

General Notes

INSTALLED PER CURRENT BUILDING CODE.

CONSTRUCTION. DO NOT SCALE OFF THE DRAWINGS.

NEW FIRE SPRINKLERS TO BE FILED UNDER SEPERATE PERMIT. SMOKE DETECTORS AND CARBON MONOXIDE ALARMS SHALL BE

1) ALL ASPECTS OF THE WORK HAVE NOT BEEN EXPLICITLY DESCRIBED. WORK NOT INCLUDED IS EXPLICITLY CALLED OUT. THESE PLANS ARE NOT INTENDED TO BE COMPLETE, OR TO BE USED ALONE AS CONTRACT, BID OR CONSTRUCTION DOCUMENTS.

2) REPORT TO THE PLAN PREPARER ANY ERRORS OR INCONSISTENCIES APPARENT OR SUSPECTED AND AWAIT A RESOLUTION BEFORE PROCEEDING. THE OBLIGATIONS OF THE PLAN PREPARER WITH RESPECT TO ANY SUCH ERRORS OR INCONSISTENCIES SHALL BE STRICTLY LIMITED TO PROVISION OF ADDITIONAL INFORMATION, IN A FORM DEEMED APPROPRIATE SOLELY BY THE PLAN PREPARER ONLY TO THE GENERAL CONTRACTOR.

3) CORRECTIONS OF ERRORS IN THIS DOCUMENT AND ADDITIONAL INFORMATION AS NECESSARY TO COMPLETE THE WORK WILL HAVE TO BE ARRANGED AND PAID FOR AS NECESSARY BY THE OWNER.

4) ALL DIMENSIONS AND (E) LOCATIONS ARE ASSUMED AND TO BE VERIFIED IN FIELD BY GENERAL CONTRACTOR PRIOR TO START OF

5) ALL DRAWINGS AND WRITTEN MATERIALS APPEARING HEREIN CONSTITUTE ORIGINAL WORK AND MAY NOT BE USED, DUPLICATED

OR DISCLOSED WITHOUT WRITTEN CONSENT OF THE PLAN PREPARER. ALL RIGHTS IN THESE DOCUMENTS ARE RESERVED BY THE PLAN

6) THESE DOCUMENTS DO NOT CREATE OR EVIDENCE ANY OBLIGATIONS OR DUTIES OF ANY KIND TO THE OWNER, ANY THIRD PARTY, OR THE GENERAL CONTRACTOR OUTSIDE OF THE ASSISTANCE IN SECURING PERMITS. THEY ARE NOT REPRESENTED TO BE IN COMPLETE CONFORMANCE WITH CODES, REGULATIONS, LAWS, OR ACCEPTED INDUSTRY PRACTICE. THE OWNER IS RESPONSIBLE FOR RETAINING A LICENSED CONTRACTOR DURING CONSTRUCTION SO THAT OBSERVATION AND ADJUSTMENT TO THE STRUCTURE CAN BE MADE AS FIELD CONDITIONS INDICATE.

7) THE CONTRACTOR SHALL BE SOLELY RESPONSIBLE FOR CONSTRUCTION MEANS, SAFETY, COSTS, SEQUENCES, PROCEDURES, DETAILS AND ALL DAMAGES TO PERSONS OR PROPERTY NOT SPECIFICALLY INDICATED FOR DEMOLITION AS PART OF THE WORK, WHETHER OR NOT COVERED BY THE PAYMENTS MADE. ANY PARTY MAKING ANY USE WHATSOEVER OF THESE DOCUMENTS, OR DERIVING ANY BENEFIT FROM THEM, SHALL FULLY INDEMNIFY AND HOLD HARMLESS THE PLAN PREPARER AND THEIR AGENTS, EMPLOYEES AND CONSULTANTS TO THE FULLEST EXTENT POSSIBLE BY LAW AGAINST ALL OMISSION OF ANY PARTY SUBCONTRACTOR OR ANY DIRECT OR INDIRECT EMPLOYEE OR AGENT, CLAIMS, LOSSES, AND EXPENSES THAT ARE CAUSED IN WHOLE OR PART BY ANY NEGLIGENT ACT OR OMISSION OF ANY PARTY, SUBCONCTRACTOR, OR ANY DIRECT OR INDIRECT EMPLOYEE OR AGENT, WHETHER OR NOT CAUSED IN PART BY A PARTY INDEMNIFIED HEREUNDER. THIS OBLIGATION SHALL NOT BE LIMITED IN ANY WAY BY ANY EMPLOYEE BENEFIT ACT OR AFFECT ANY OTHER RIGHT OR OBLIGATION.

8) GENERAL CONTRACTOR TO PROVIDE MOCK-UPS OF FINISH MATERIALS TO ARCHITECT PRIOR TO ORDERING AND MANUFACTURE.

Legal Notes

THE OWNER AGREES TO INDEMNIFY THE PLAN PREPARER, AND TO HOLD THE PLAN PREPARER HARMLESS, AGAINST ANY AND ALL LOSSES, DAMAGES, COSTS, EXPENSES (INCLUDING REASONABLE ATTORNEYS FEES), LIABILITIES AND OTHER OBLIGATIONS WHICH THE PLAN PREPARER INCURS AS A RESULT OF ANY THIRD PART CLAIM, ACTION OR PROCEEDING BASED ON ALLEGATION THAT THE PLAN PREPARER HAS BREACHED A MATERIAL TERM OF THIS AGREEMENT IN ANY MANNER OTHER THAN BY THE PLAN PREPARER'S SOLE NEGLIGENCE OR WILLFUL MISCONDUCT IN THE PERFORMANCE OF SERVICES, PROVIDED HOWEVER THAT THE PLAN PREPARER SHALL PROMPTLY NOTIFY THE OWNER IN WRITING OF ANY CLAIM OR THREATENED OR ACTUAL ACTION PROCEEDING. THE PLAN PREPARER SHALL CONTROL THE DEFENSE OF ANY SUCH CLAIM, ACTION OR PROCEEDING, INCLUDING THE SELECTION OF COUNSEL, BUT THE OWNER SHALL HAVE THE RIGHT TO PARTICIPATE IN ANY ACTION OR PROCEEDING WITH COUNSEL OF THE OWNER'S SELECTION.

NEITHER THE PLAN PREPARER NOR THE PLAN PREPARER'S CONSULTANTS, AGENTS, REPRESENTATIVES OR EMPLOYEES SHALL BE LIABLE TO THE OWNER FOR ANY INDIRECT, SPECIAL RELIANCE, INCIDENTAL, CONSEQUENTIAL OR EXEMPLARY DAMAGES (OTHER THAN FOR PERSONAL INJURY) ARISING OUT OF, OR IN CONNECTION WITH THE PERFORMANCE OF SERVICES UNDER THIS AGREEMENT, WHETHER IN ACTION BASED ON CONTRACT INCLUDING BREACH OF REPRESENTATION OR WARRANTY, DELAY, NEGLIGENCE (ACTIVE OR PASSIVE),

THE ENTIRE LIABILITY OF THE PLAN PREPARER'S CONSULTANTS, AGENTS AND EMPLOYEES, THAT DOES NOT INVOLVE A THIRD PARTY CLAIM, SHALL IN NO EVENT EXCEED THE TOTAL AMOUNT PAID TO THE PLAN PREPARER BY THE OWNER FOR SERVICES PERFORMED HEREUNDER.

THE SOLE REMEDY FOR ANY BREACH OR ALLEGED BREACH R.E. LIABILITY IS THE PREPARATION OF CORRECTED DESIGN DOCUMENTS AS MAY BE REQUIRED BY THE JURISDICTION WHICH ISSUES PERMIT.

Project Information Building Code Data TYPE OF OCCUPANCY ZONING:

OCCUPANCY:

CONSTRUCTION TYPE:

DESCRIPTION OF USE

LOCATED IN WUI:

CUT:

PROPOSED:

APPROVED BUILDABLE AREA:

PROPOSED BUILDING AREA:

PROPOSED FLOOR AREA RATIO:

MIN. SETBACKS FOR EXTERIOR WALLS:

MAX. HEIGHT FOR MAIN BUILDING:

PROPOSED FLOOR AREA:

ARP-60 TYPE I CONSTRUCTION TYPE: R-3 NUMBER OF STORIES: V-A FIRE SPRINKLERS: YES* 35,477 SQFT PHOTOVOLTAIC SYSTEM: YES* SINGLE FAMILY * FIRE SPRINKLERS AND PHOTOVOLTAIC SYSTEM UNDER A RESIDENTIAL DEFERRED SUBMITTAL. YES

ALL WORK TO CONFORM TO 2019 CRC, CBC, CFC, CPC, CMC, EXISTING LOT AREA (NO CHANGE): 24 ACRES (1,045,440 SOFT) CEC, CEnC, AND CGBC 5,481 GSF - BEARING AND NON-BEARING WALLS LESS THAN 5' FROM 4,942 GSF PROPERTY LINE TO BE 1- HOUR RATED. 0.01% (0.0047) - OPENINGS NOT PERMITTED LESS THAN 3' FROM PROPERTY LINE PROPOSED AREA OF ADDTL DISTURBANCE: SEE CIVIL 19,642 GSF

PROPOSED LOT COVERAGE: GRADING CALCULATIONS: 1,428 CUBIC YARDS 3,056 CUBIC YARDS 2,078 (FILL) PROPOSED PARKING: 6 TOTAL 2 x GARAGE 4 x EXTERIOR

Cal Green Construction Requirements

26'-3.5"

* CONTRACTOR SHALL PROVIDE, AT THE TIME OF FINAL INSPECTION, AN OPERATION AND MAINTENANCE MANUAL TO THE OWNER OR OCCUPANT, ADDRESSING ITEMS 1 THROUGH 10 IN CALGREEN SECTION 4.410.1.

* PER CALGREEN SECTION 4.408.2, CONTRACTOR SHALL PROVIDE AND SUBMIT A CONSTRUCTION WASTE MANAGEMENT PLAN, DIVERTING A MINIMUM OF 65% OF WASTE GENERATED AT THE SITE TO RECYCLE OR SALVAGE, TO THE BUILDING DEPARTMENT. THE FOLLOWING INFORMATION SHALL BE PROVIDED IN THE PLAN:

· IDENTIFY MATERIALS TO BE RECYCLED, REUSED, OR SALVAGED · SPECIFY IF MATERIALS WILL BE SORTED ON SITE OR MIXED FOR TRANSPORTATION

IDENTIFY THE DIVERSION FACILITY(IES) TO BE USED · IDENTIFY CONSTRUCTION METHODS TO BE USED TO LIMIT WASTE GENERATION

SPECIFY THAT THE AMOUNT OF MATERIALS DIVERTED ARE TO BE CALCULATED BY WEIGHT OR VOLUME * AUTOMATIC IRRIGATION SYSTEMS CONTROLLERS INSTALLED AT THE TIME OF FINAL INSPECTION SHALL BE WEATHER-BASED. * PROTECT ANNULAR SPACES AROUND PIPES, ELECTRIC CABLES, AND CONDUITS AT EXTERIOR WALLS AGAINST THE PASSAGE OF

* COVER DUCT OPENINGS AND OTHER RELATED AIR DISTRIBUTION COMPONENT OPENINGS DURING CONSTRUCTION.

* ADHESIVES, SEALANTS, AND CAULKS SHALL BE COMPLIANT WITH VOC AND OTHER TOXIC COMPOUND LIMITS. * PAINTS, STAINS, AND OTHER COATINGS SHALL BE COMPLIANT WITH VOC LIMITS.

* AEROSOL PAINTS AND COATINGS SHALL BE COMPLIANT WITH PRODUCT WEIGHTED MIR LIMITS FOR ROC AND OTHER TOXIC COMPOUNDS. VERIFICATION OF COMPLIANCE SHALL BE PROVIDED.

* CARPET AND CARPET SYSTEMS SHALL BE COMPLIANT WITH VOC LIMITS.

* MINIMUM OF 80% OF FLOOR AREA RECEIVING RESILIENT FLOORING SHALL COMPLY WITH SECTION 4.504.4. * PARTICLEBOARD, MEDIUM DENSITY FIBERBOARD, AND HARDWOOD PLYWOOD USED IN INTERIOR FINISH SYSTEMS SHALL COMPLY WITH

LOW FORMALDEHYDE EMISSION STANDARDS. * INSTALL CAPILLARY BREAK AND VAPOR RETARDER AT SLAB ON GRADE FOUNDATIONS.

* CHECK MOISTURE CONTENT OF BUILDING MATERIALS USED IN WALL AND FLOOR FRAMING BEFORE ENCLOSURE. * EACH BATHROOM SHALL BE MECHANICALLY VENTILATED WITH AN ENERGY STAR EXHAUST FAN, AND FAN MUST BE CONTROLLED BY A

* DUCT SYSTEMS SHALL BE SIZED, DESIGNED, AND EQUIPMENT SELECTED PER SECTION 4.507.2. HVAC SYSTEM INSTALLERS MUST BE

TRAINED AND CERTIFIED AND SPECIAL INSPECTORS EMPLOYED BY THE ENFORCING AGENCY MUST BE QUALIFIED. Abbreviations

INTERIOR

/ (00	ic viations	JT	JOINT	
+, &	AND	LIN	LINEAR	
@	AT			
_		LL	LOWER LEVEL	
ADV	ABOVE	LOC	LOCATION	
ADA	AMERICAN WITH DISABILITIES ACT	LP	LOW POINT	
AFF	ABOVE FINISHED FLOOR			
AL	ALUMINUM	MAX	MAXIMUM	
ANOD	ANODISZED	MECH	MECHANICAL	
APPROX	APPROXIMATELY	MEP	MECHANICAL ELECTRICAL	PLUMBING
		MFR	MANUFACTURER	
B.O.	BOTTOM OF	MIN	MINIMUM	
BD	BOARD	MISC	MISCELLANEOUS	
BLW	BELOW	MTL	METAL	
BS	BOTH SIDES			
BTWN	BETWEEN	(N)	NEW	
BLDG	BUILDING	NEC	NECESSARY	
BLK	BLOCK, BLOCKING	NTS	NOT TO SCALE	
BYND	BEYOND	NIC	NOT IN CONTRACT	
		NIS	NOT IN SCOPE	
CL	CENTER LINE	NO.	NUMBER	
CLG	CEILING			
CLMN	COLUMN	OC	ON CENTER	
CMU	CONCRETE MASONRY UNIT	OD	OVERFLOW DRAIN	
CONC	CONCRETE	OP	OWNER PROVIDED	
CONT	CONTINUOUS	ОТВ	OPEN TO BEYOND	
33.11		Old	OI EN TO BETOIND	
DEMO	DEMOLITION	PR	PAIR	
DIA	DIAMETER			
DIM	DIMENSION	(P)	PROPOSED	
DN	DOWN	PLYWD	PLYWOOD	
DWG	DRAWING	PT	PAINT	
DWG	DIAWING	DAD	DADUIC	
	FACIL	RAD	RADIUS	
EA	EACH	RD	ROOF DRAIN	
EL	ELEVATION	REQ'D	REQUIRED	
ELEC	ELECTRIC	RM	ROOM	
E.O.	EDGE OF	RO	ROUGH OPENING	
EQ	EQUAL			
EQUIP	EQUIPMENT	SC	SOLID CORE	
(E)	EXISTING	SCD	SEE CIVIL DRAWINGS	
		SCHED	SCHEDULE	
FB	FABRIC	SEC	SECTION	
FD	FLOOR DRAIN	SHT	SHEET	
FDN	FOUNDATION	SIM	SIMILAR	
F.O.	FACE OF	SPEC	SPECIFICATIONS	
F.O.F.	FACE OF FINISH	SQ	SQUARE	
FF	FINISHED FLOOR	SS	STAINLESS STEEL	
FL	FLOOR	SSB	SIDE SET BACK	
FIG	FIGURE	STD	STANDARD	
FT	FEET	STL	STEEL	
		STFRONT	STOREFRONT	
GA	GAUGE, GAGE	STRUC	STRUCTURAL	
GALV	GALVANIZED	ST&V	STAIN & VARNISH	
G.B.	GRAB BAR	SUSP	SUSPENDED	
GYP	GYPSUM BOARD			
GL	GLASS	TBD	TO BE DECIDED	
GR	GRADE	T.O.	TOP OF	
		THK	THICK	
HDWD	HARDWOOD	TYP	TYPICAL	
НМ	HOLLOW METAL			
HORZ	HORIZONTAL	UNO	UNLESS NOTED OTHERWISE	
HP	HIGH POINT		2	
HR	HOUR	VEN	VENEER	
Н	HEIGHT	VENT	VENTILATION	
HVAC	HEAT / VENTILATION /	VERT	VERTICAL	
	AIR CONDITIONING	VEST	VESTIBULE	
		VIF	VERIFY IN FIELD	
ID	INSIDE DIMENSION	VOL	VOLUME	
IN	INCH	VOL	. 0 _ 0	
INCL	INCLUDING	WA	WASHER	
INFO	INFORMATION	W/	WITH	
INSUL	INSULATION	WC	WATER CLOSET	
INT	INTERIOR	WD	WOOD	

WOOD WITHOUT

Sheet Index

General Information G-001 GENERAL INFORMATION Architectural A-001 SITE PLAN MATERIALS PAGE A-003 GROUND FLOOR PLAN A-102 **ROOF PLAN** PARTIAL FLOOR PLAN (GROUND FLOOR) PARTIAL FLOOR PLANS (SECOND FLOOR & GARAGE) A-201 **ELEVATIONS** A-202 **ELEVATIONS** A-301 SECTIONS C1.0 GRADING, DRAINAGE & UTILITY C1.1 EXISTING CONDITIONS WATER MAP C1.2 PROPOSED CONDITIONS WATER MAP C2.0 DRIVEWAY PROFILE C3.0 ENLARGED GRADING & DRAINAGE PLAN UTILITY PLAN C4.0 C5.0 STORMWATER CONTROL PLAN C5.1 STORMWATER CONTROL NOTES & DETAILS CC1 CONSTRAINTS MAP CMP CONSTRUCTION MANAGEMENT PLAN EC1.0 **EROSION CONTROL PLAN** EC1.1 EROSION CONTROL PLAN SEPTIC PLAN

LANDSCAPE PLAN

VMP NOTES

LANDSCAPE PLAN NOTES

VEGETATION MANAGEMENT PLAN

L0.0

L0.1

L1.0

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Project Title

FREY RESIDENCE

5760 LUCAS VALLEY RD. NICASIO, CA 94946 APN: 121-210-59

Sheet Description

GENERAL INFORMATION

2024.05.13

Project Number:

23205 Drawn by:

Sheet Number: XX of xx

GENERAL NOTES:


1. PROVIDE (N) WATER LINE FROM SHARED WELLS ADJ. TO LUCAS VALLEY ROAD TO SITE. PROVIDE METERING AS REQUIRED BY SUBDIVISION DOCUMENTS. WATER FROM WELLS TO BE STORES ON SITE IN A WATER STORAGE TANK. TANK WILL PROVIDE POTABLE WATER FOR USE IN THE RESIDENCE AS WELL AS FIRE SUPPRESSION. WATER TANK TO MAINTAIN A RESERVE FOR FIRE SUPPRESSION AS REQUIRED BY MARIN COUNTY FIRE DEPARTMENT, SCD. 2. PROVIDE (N) UNDERGROUND ELECTRIC UTILITY LINES AND ASSOCIATED HOOK UP & METER TO (N) RESIDENCE, SCD.

3. PROVIDE (N) PHOTOVOLTAIC SOLAR PANELS ON ROOF OF (N) RESIDENCE WITH BATTERY BACK UP FOR SUPPLEMENTARY ELECTRIC POWER. 4. PROVIDE (N) LP TANK FOR RESIDENCE. LP TO BE USED FOR HOME HEATING AND GAS BURNING APPLIANCES.

5. PROVIDE (N) SEPTIC SYSTEM FOR ON SITE TREATMENT OF WASTE WATER ASSOCIATED W./ (N) RESIDENCE, SCD. 6. TRIM AND REMOVE (E) VEGETATION AROUND (N) STRUCTURE TO PROVIDE DEFENSIBLE SPACE AS REQUIRED BY MARIN COUNTY FIRE DEPARTMENT, SLD.

7. PROVIDE (N) 3,500 GALLON RAINWATER COLLECTION TANK FOR IRRIGATION PURPOSES, SCD AND SLD. 8. ROADWAYS AND DRIVEWAYS SHALL HAVE A MINIMUM CLEARANCE OF NOT LESS THAN 20-FT. HORIZONTAL BY 15-FT. VERTICAL CLEARANCE. NO OBJECT OR VEGETATION SHALL ENCROACH INTO THIS HORIZONTAL AND VERTICAL PLANE. 9. DRIVEWAYS SHALL BE NOT LESS THAN 12 FEET WIDE (16-FT IN THE WILDLAND-URBAN INTERFACE) CAPABLE OF

ACCOMMODATING 60,000 GVW AND CONFORM TO MCFD STANDARDS. 10. 'KNOX' KEY ACCESS SHALL BE INSTALLED FOR GATE ACCESS AT THE PREMISES CONFORMING TO MCFD STANDARDS.

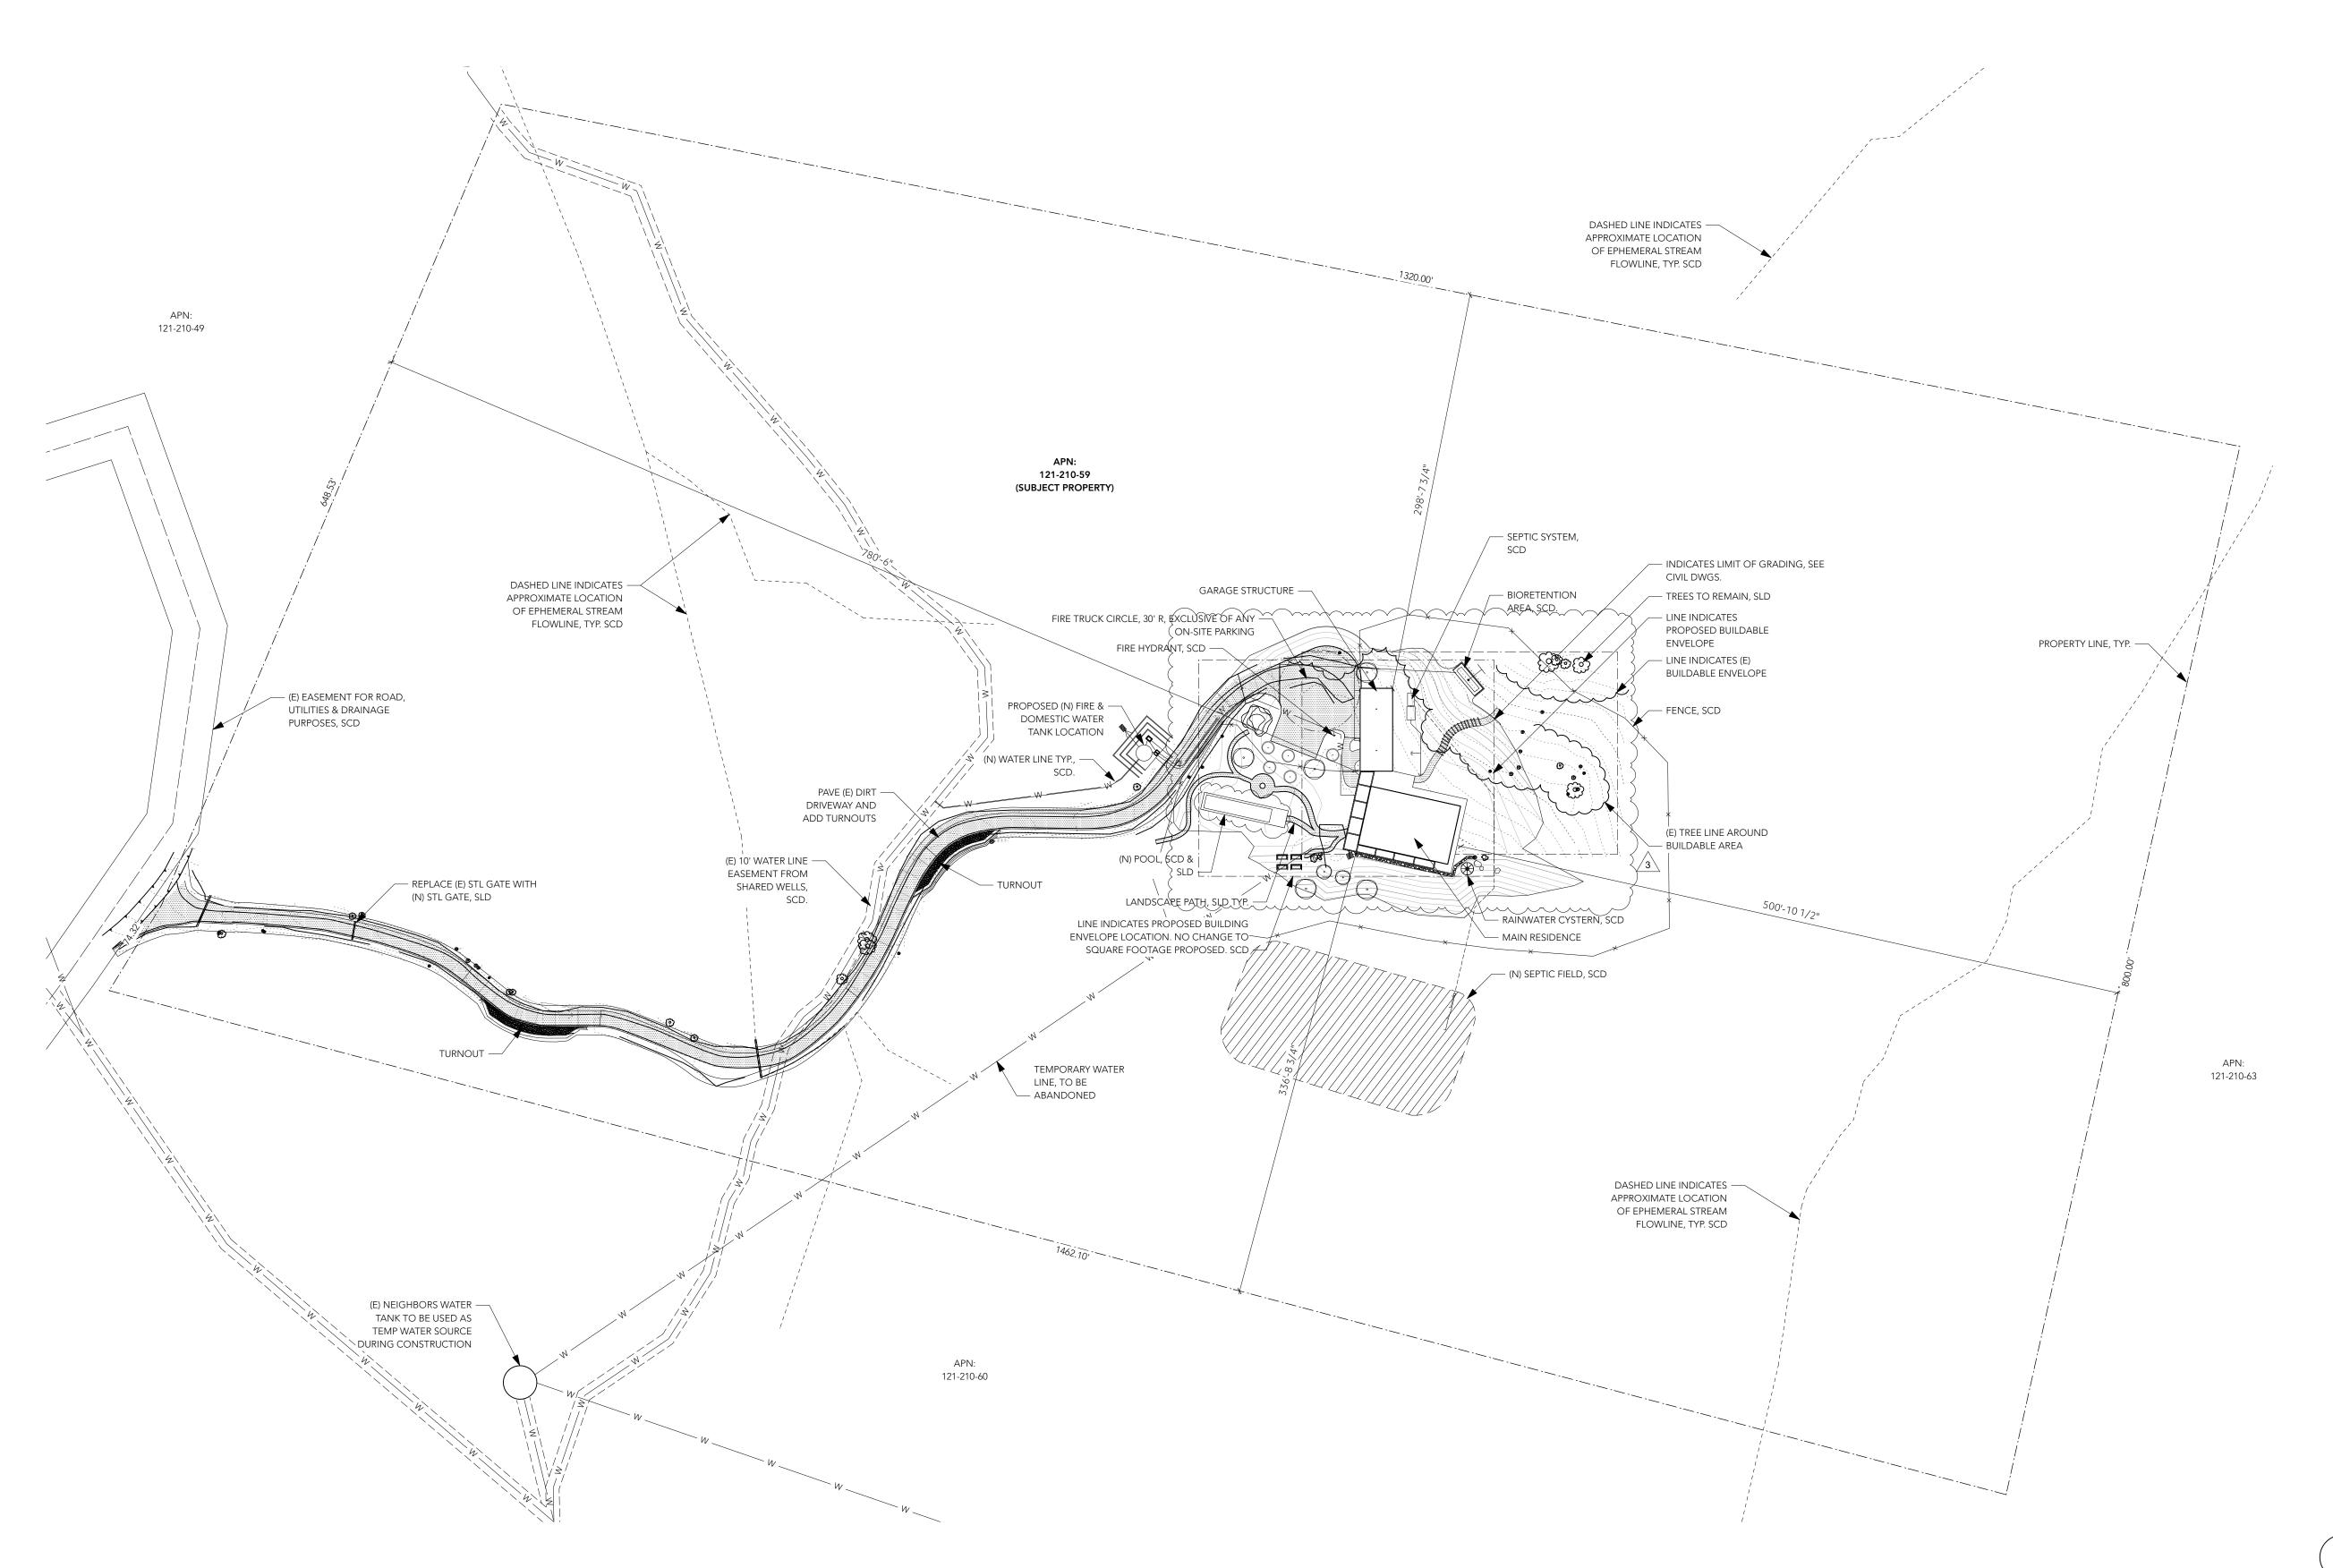

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Project Title

FREY RESIDENCE

5760 LUCAS VALLEY RD. NICASIO, CA 94946 APN: 121-210-59

Sheet Description

SITE PLAN

Date: 2024.05.13

Project Number: 23205


Drawn by: GVL

Sheet Number:


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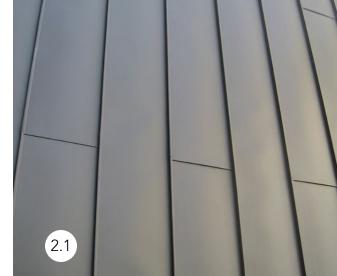
Sheet Number:

Facade Perspective:

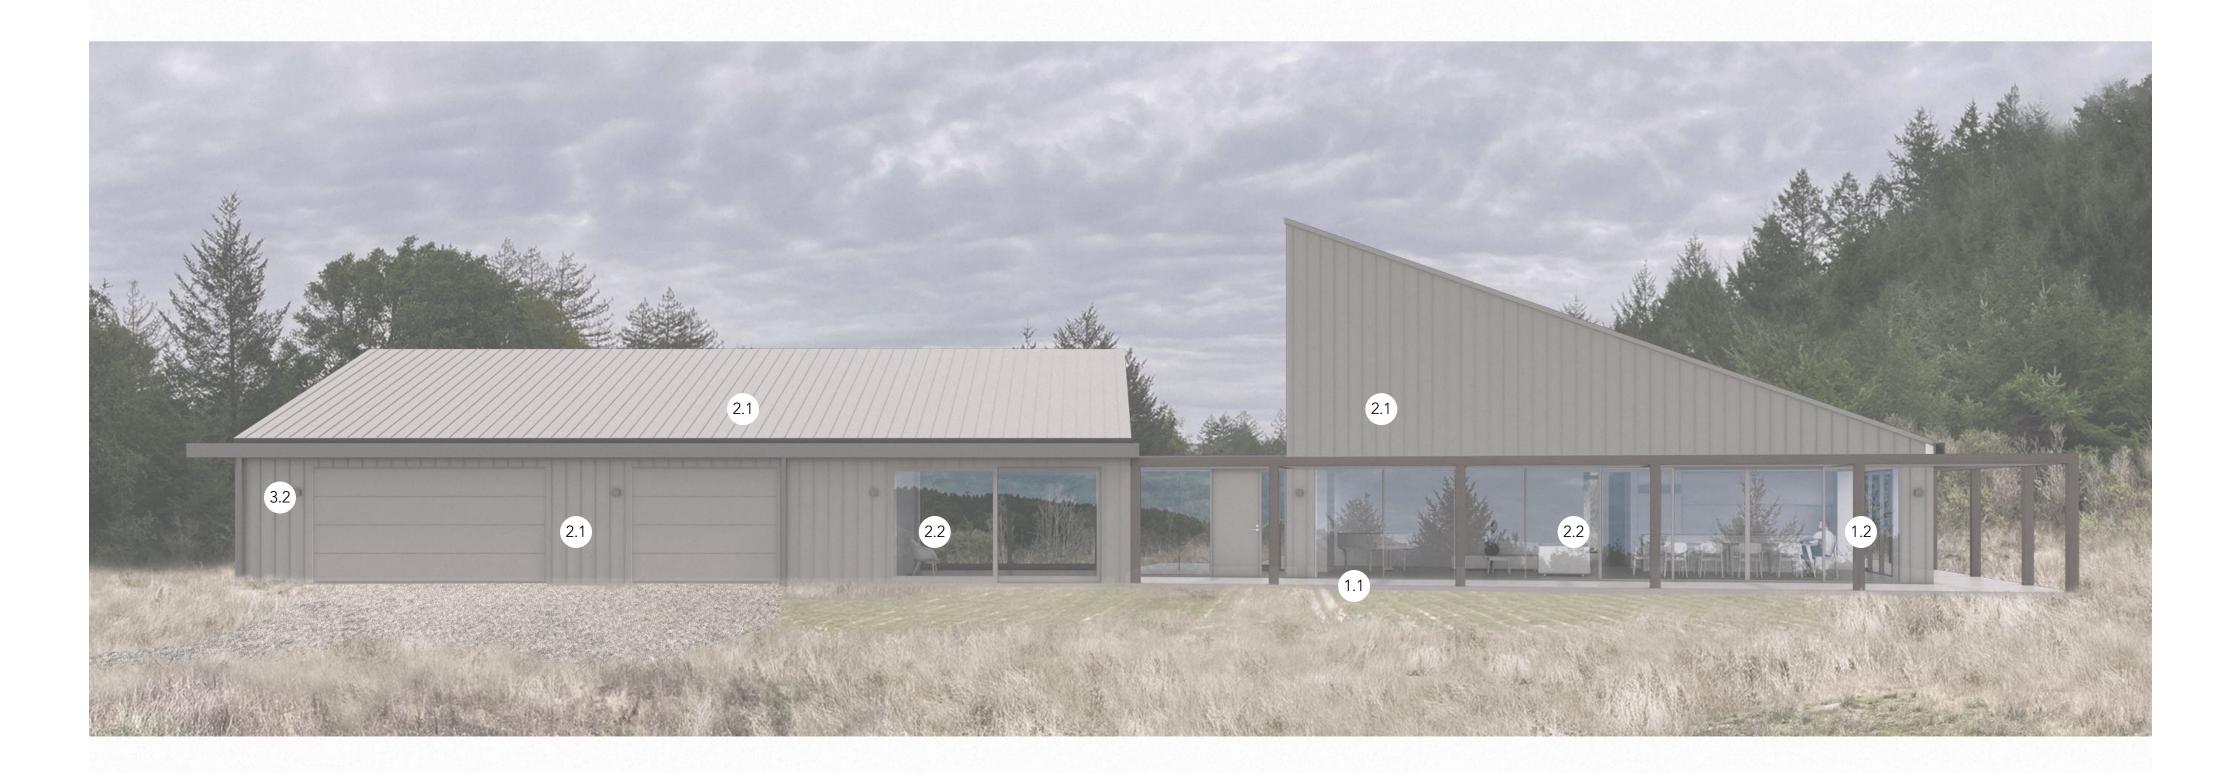

Materials Legend:



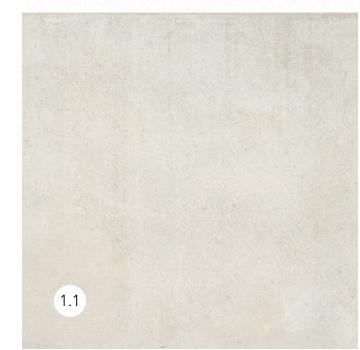







1.1 CONCRETE FOUNDATION, EXTERIOR DECK & RETAINING 2.1 WARM GRAY METAL SIDING AND ROOFING WALLS - WARM GRAY CONCRETE, DYED

3.1 METAL RAINWATER COLLECTION CISTERN

4.1 STACKED STONE RETAINING WALLS

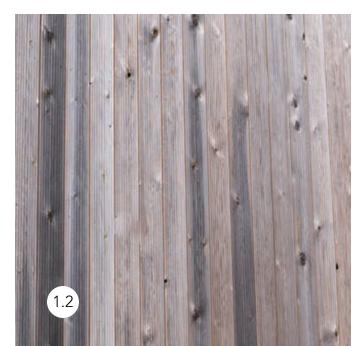



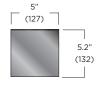



1.2 CLEAR CEDAR SHADE STRUCTURE

2.2 CLEAR ANODIZED ALUMINUM WINDOWS & DOORS

3.2 EXTERIOR WALL SCONCE AND GATE LIGHTING SQ500 SERIES BY LUMINIS

DARK SKY COMPLIANT

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Project Title

FREY RESIDENCE

5760 LUCAS VALLEY RD. NICASIO, CA 94946 APN: 121-210-59

Sheet Description

MATERIALS AND COLORS

Date: 2024.05.13

Project Number: 23205


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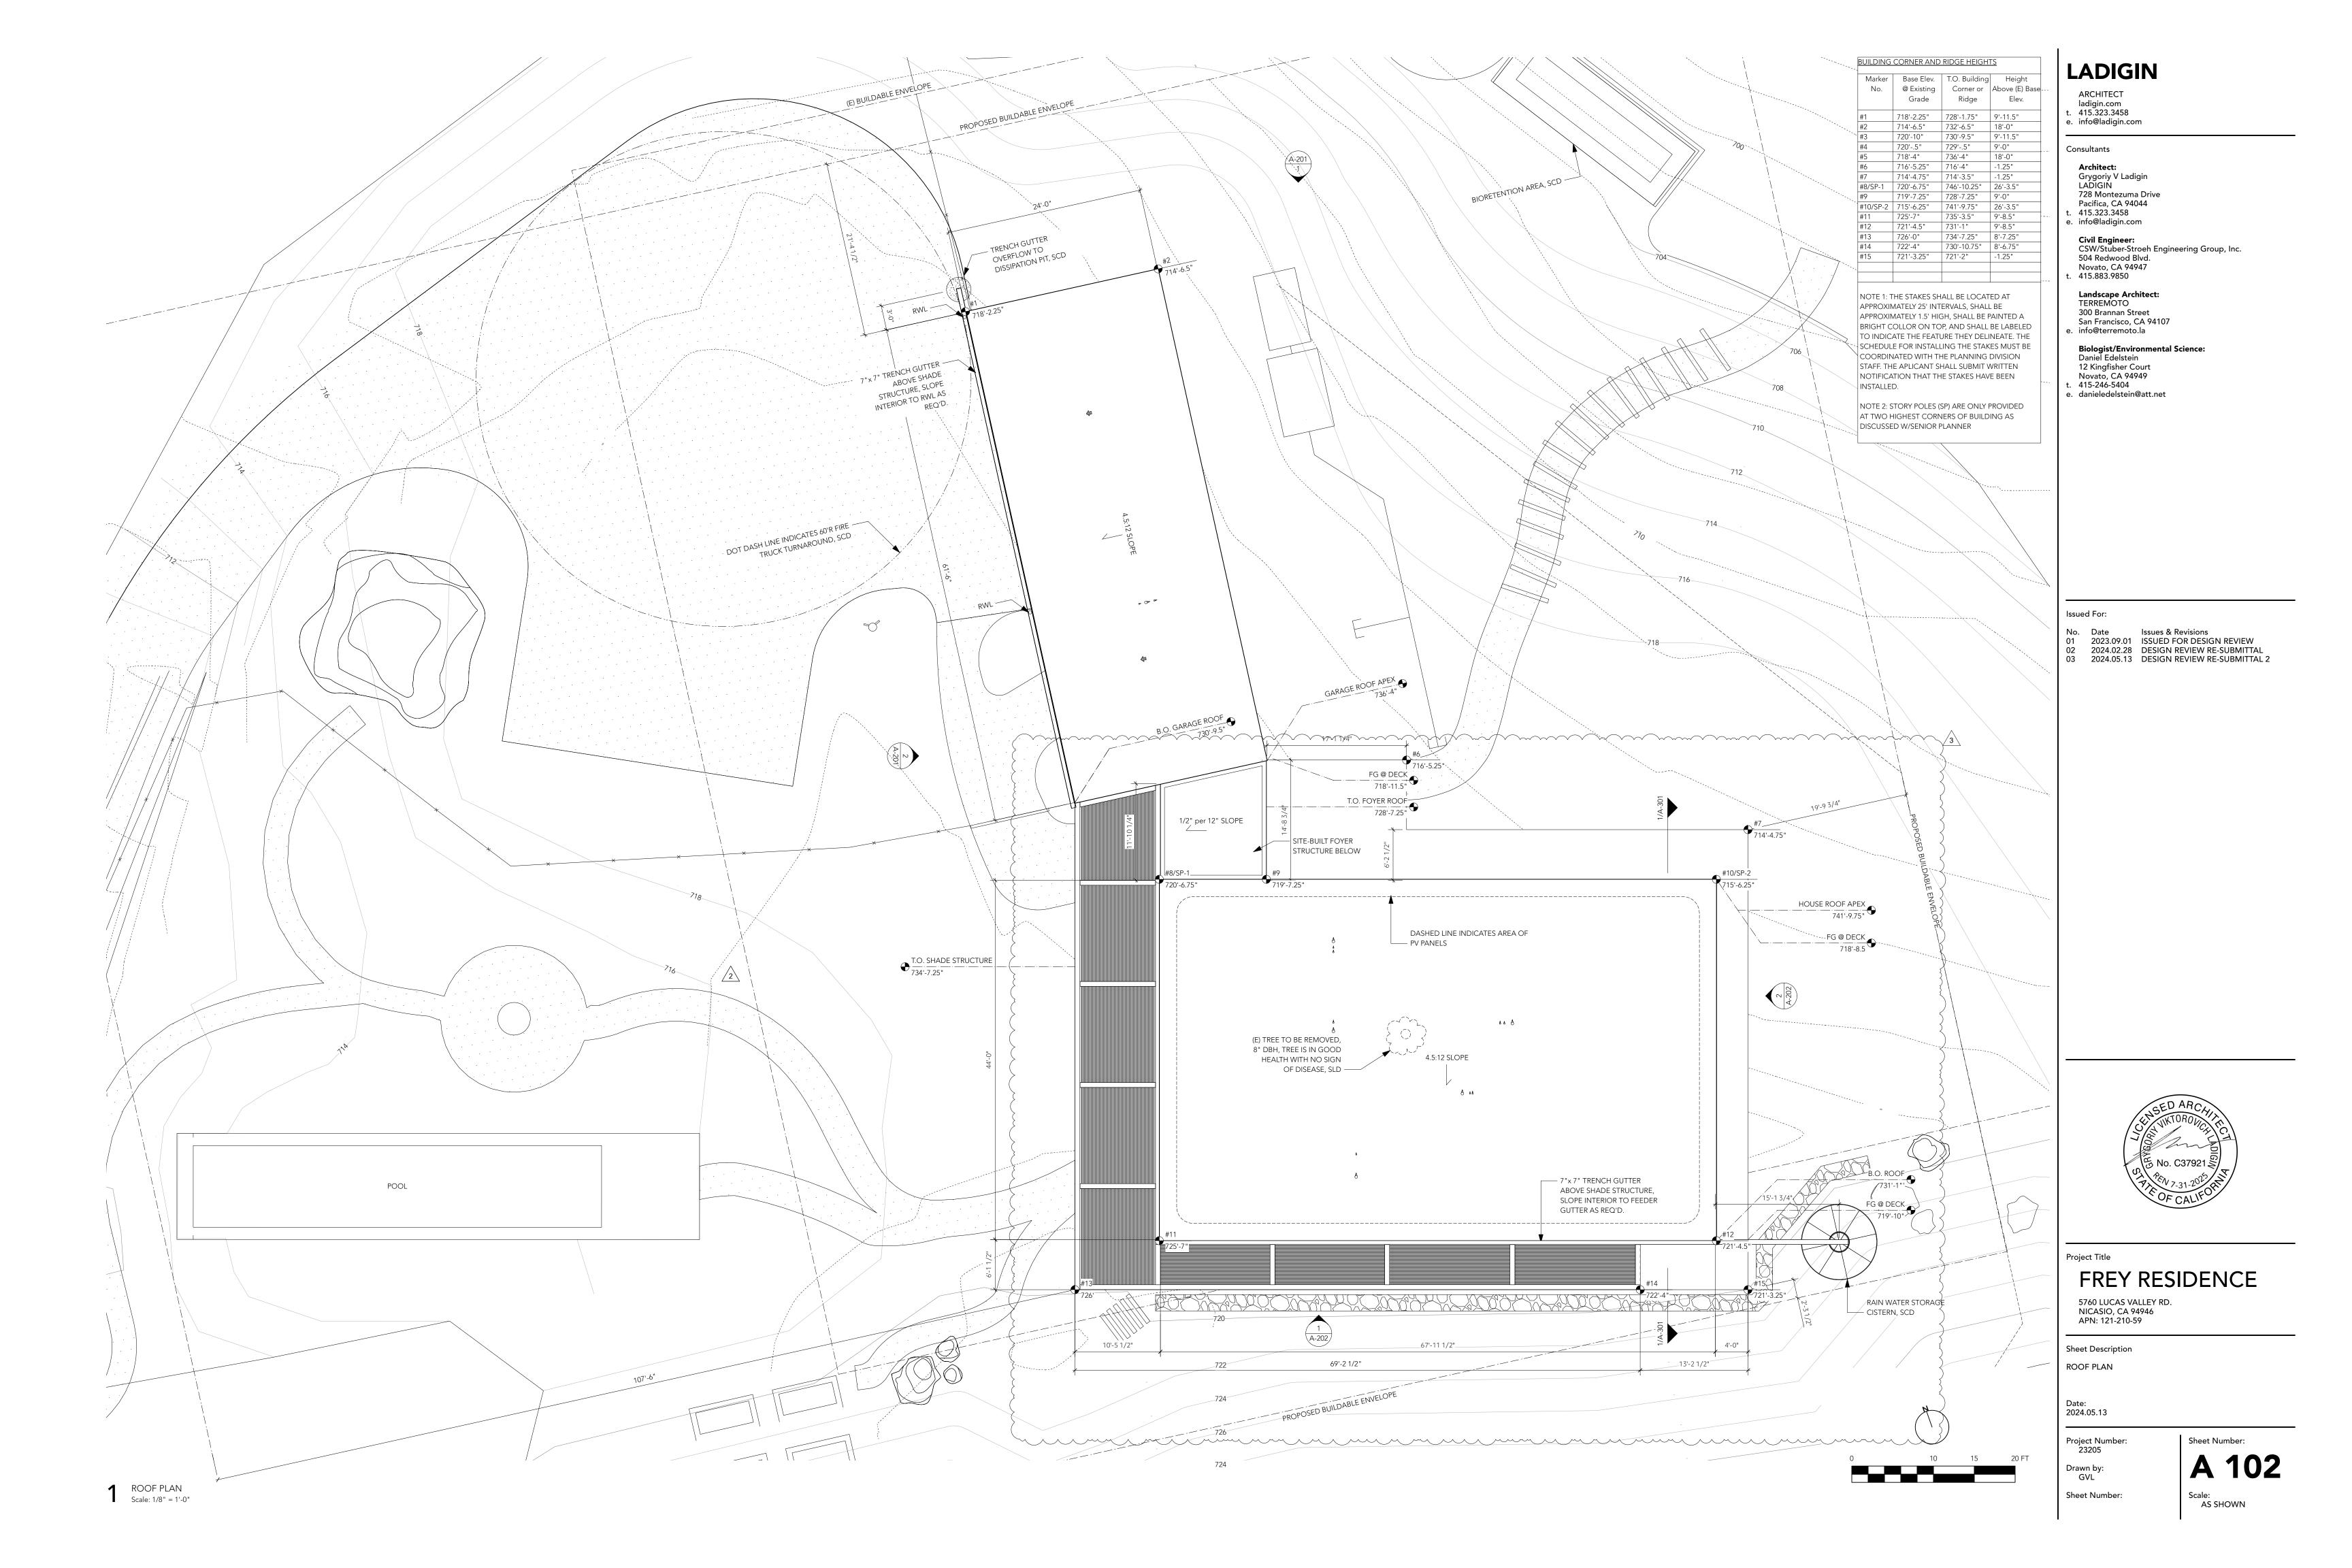
GVL


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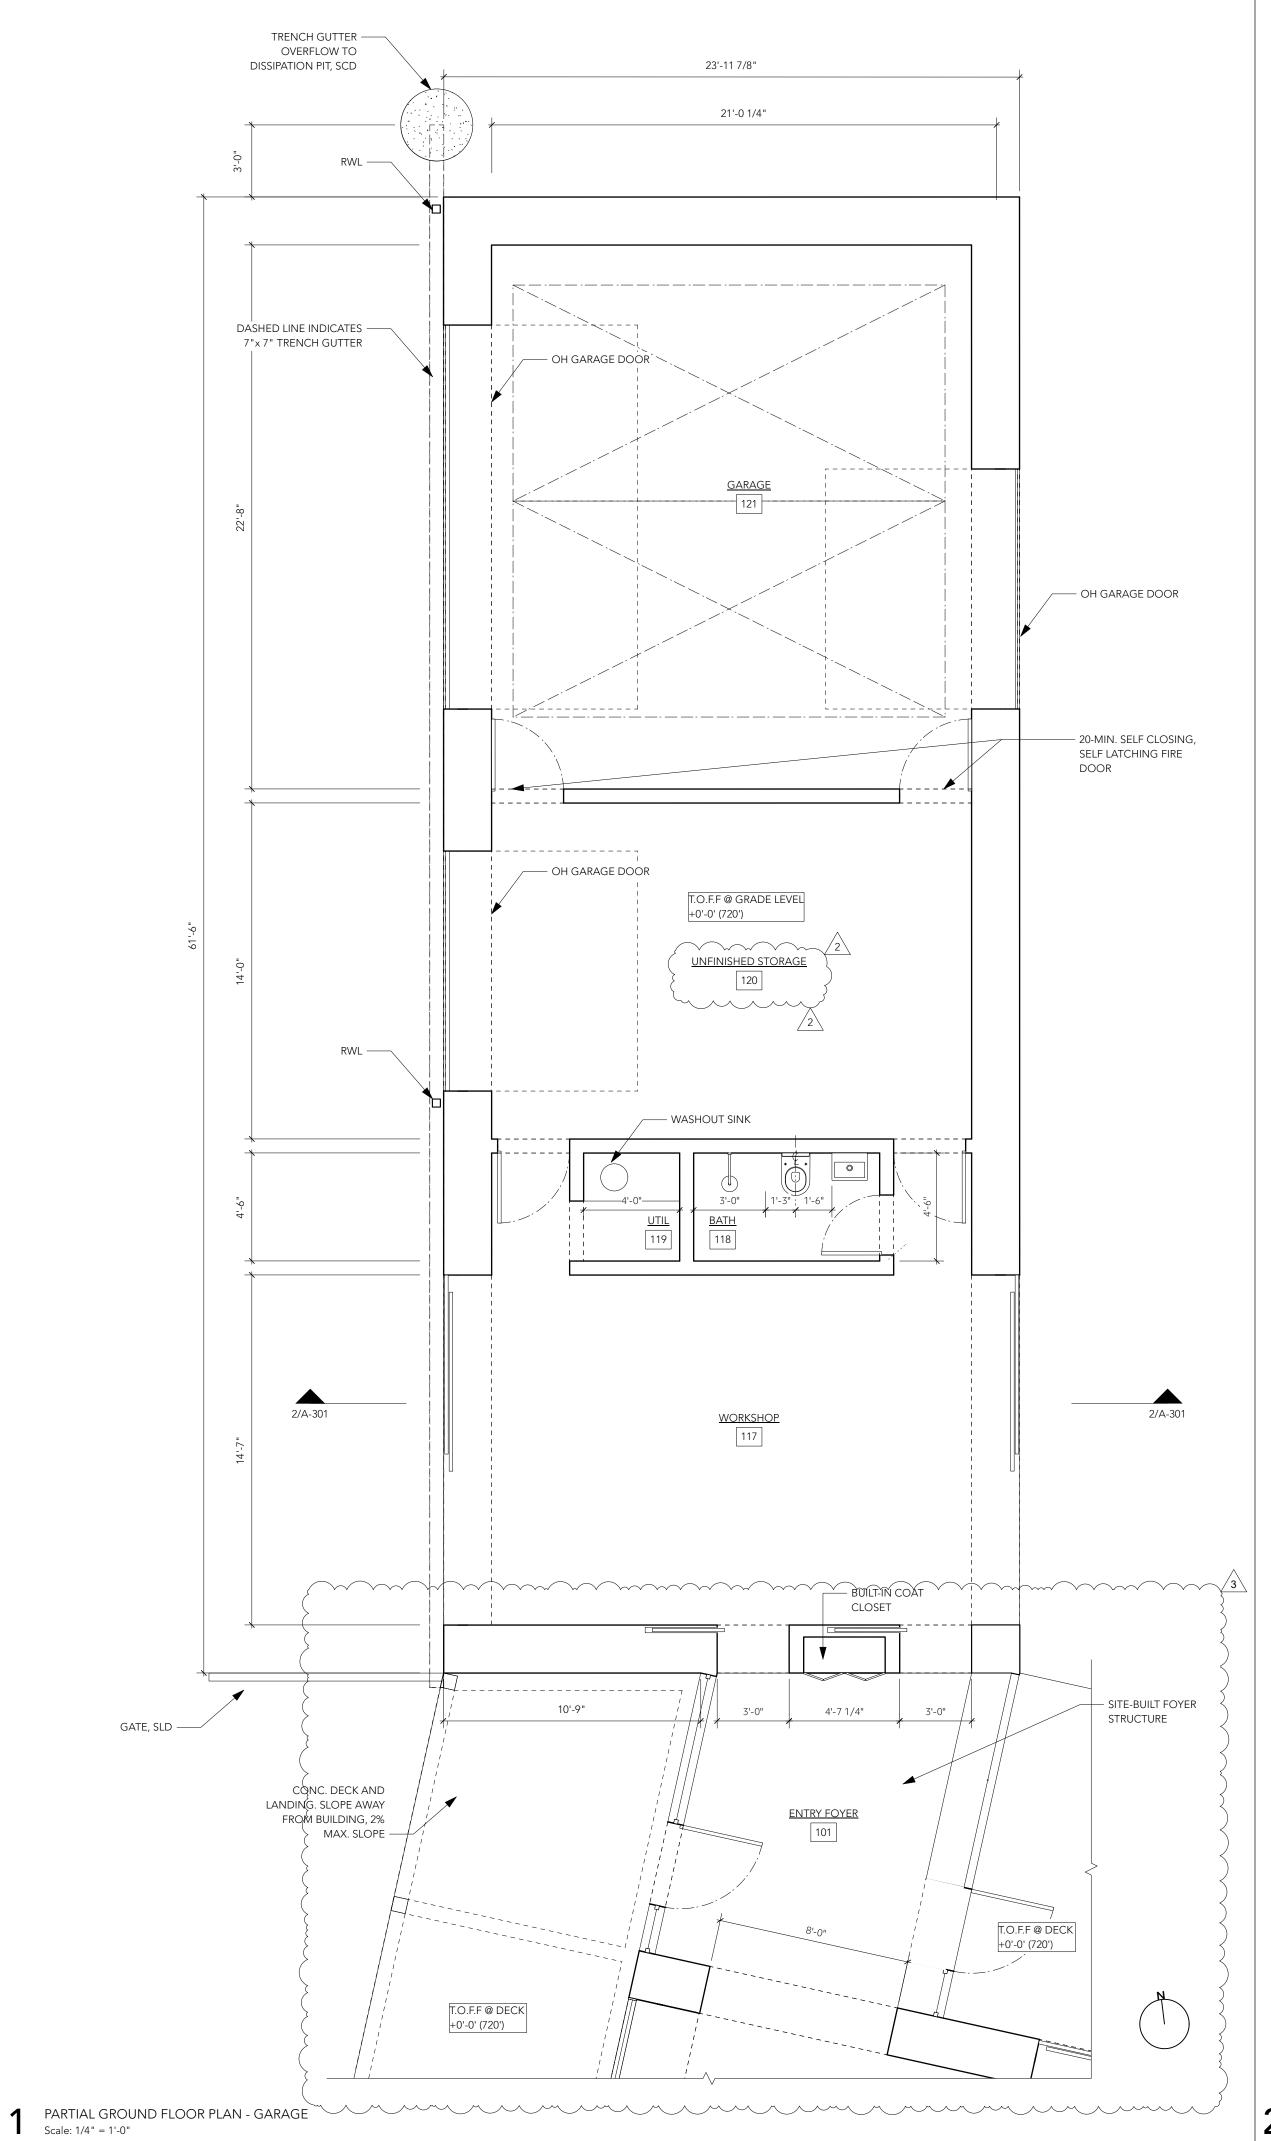
PARTIAL FLOOR PLAN (RESIDENCE) GROUND LEVEL


Date: 2024.05.13

Project Number: 23205 Drawn by:

GVL Sheet Number:

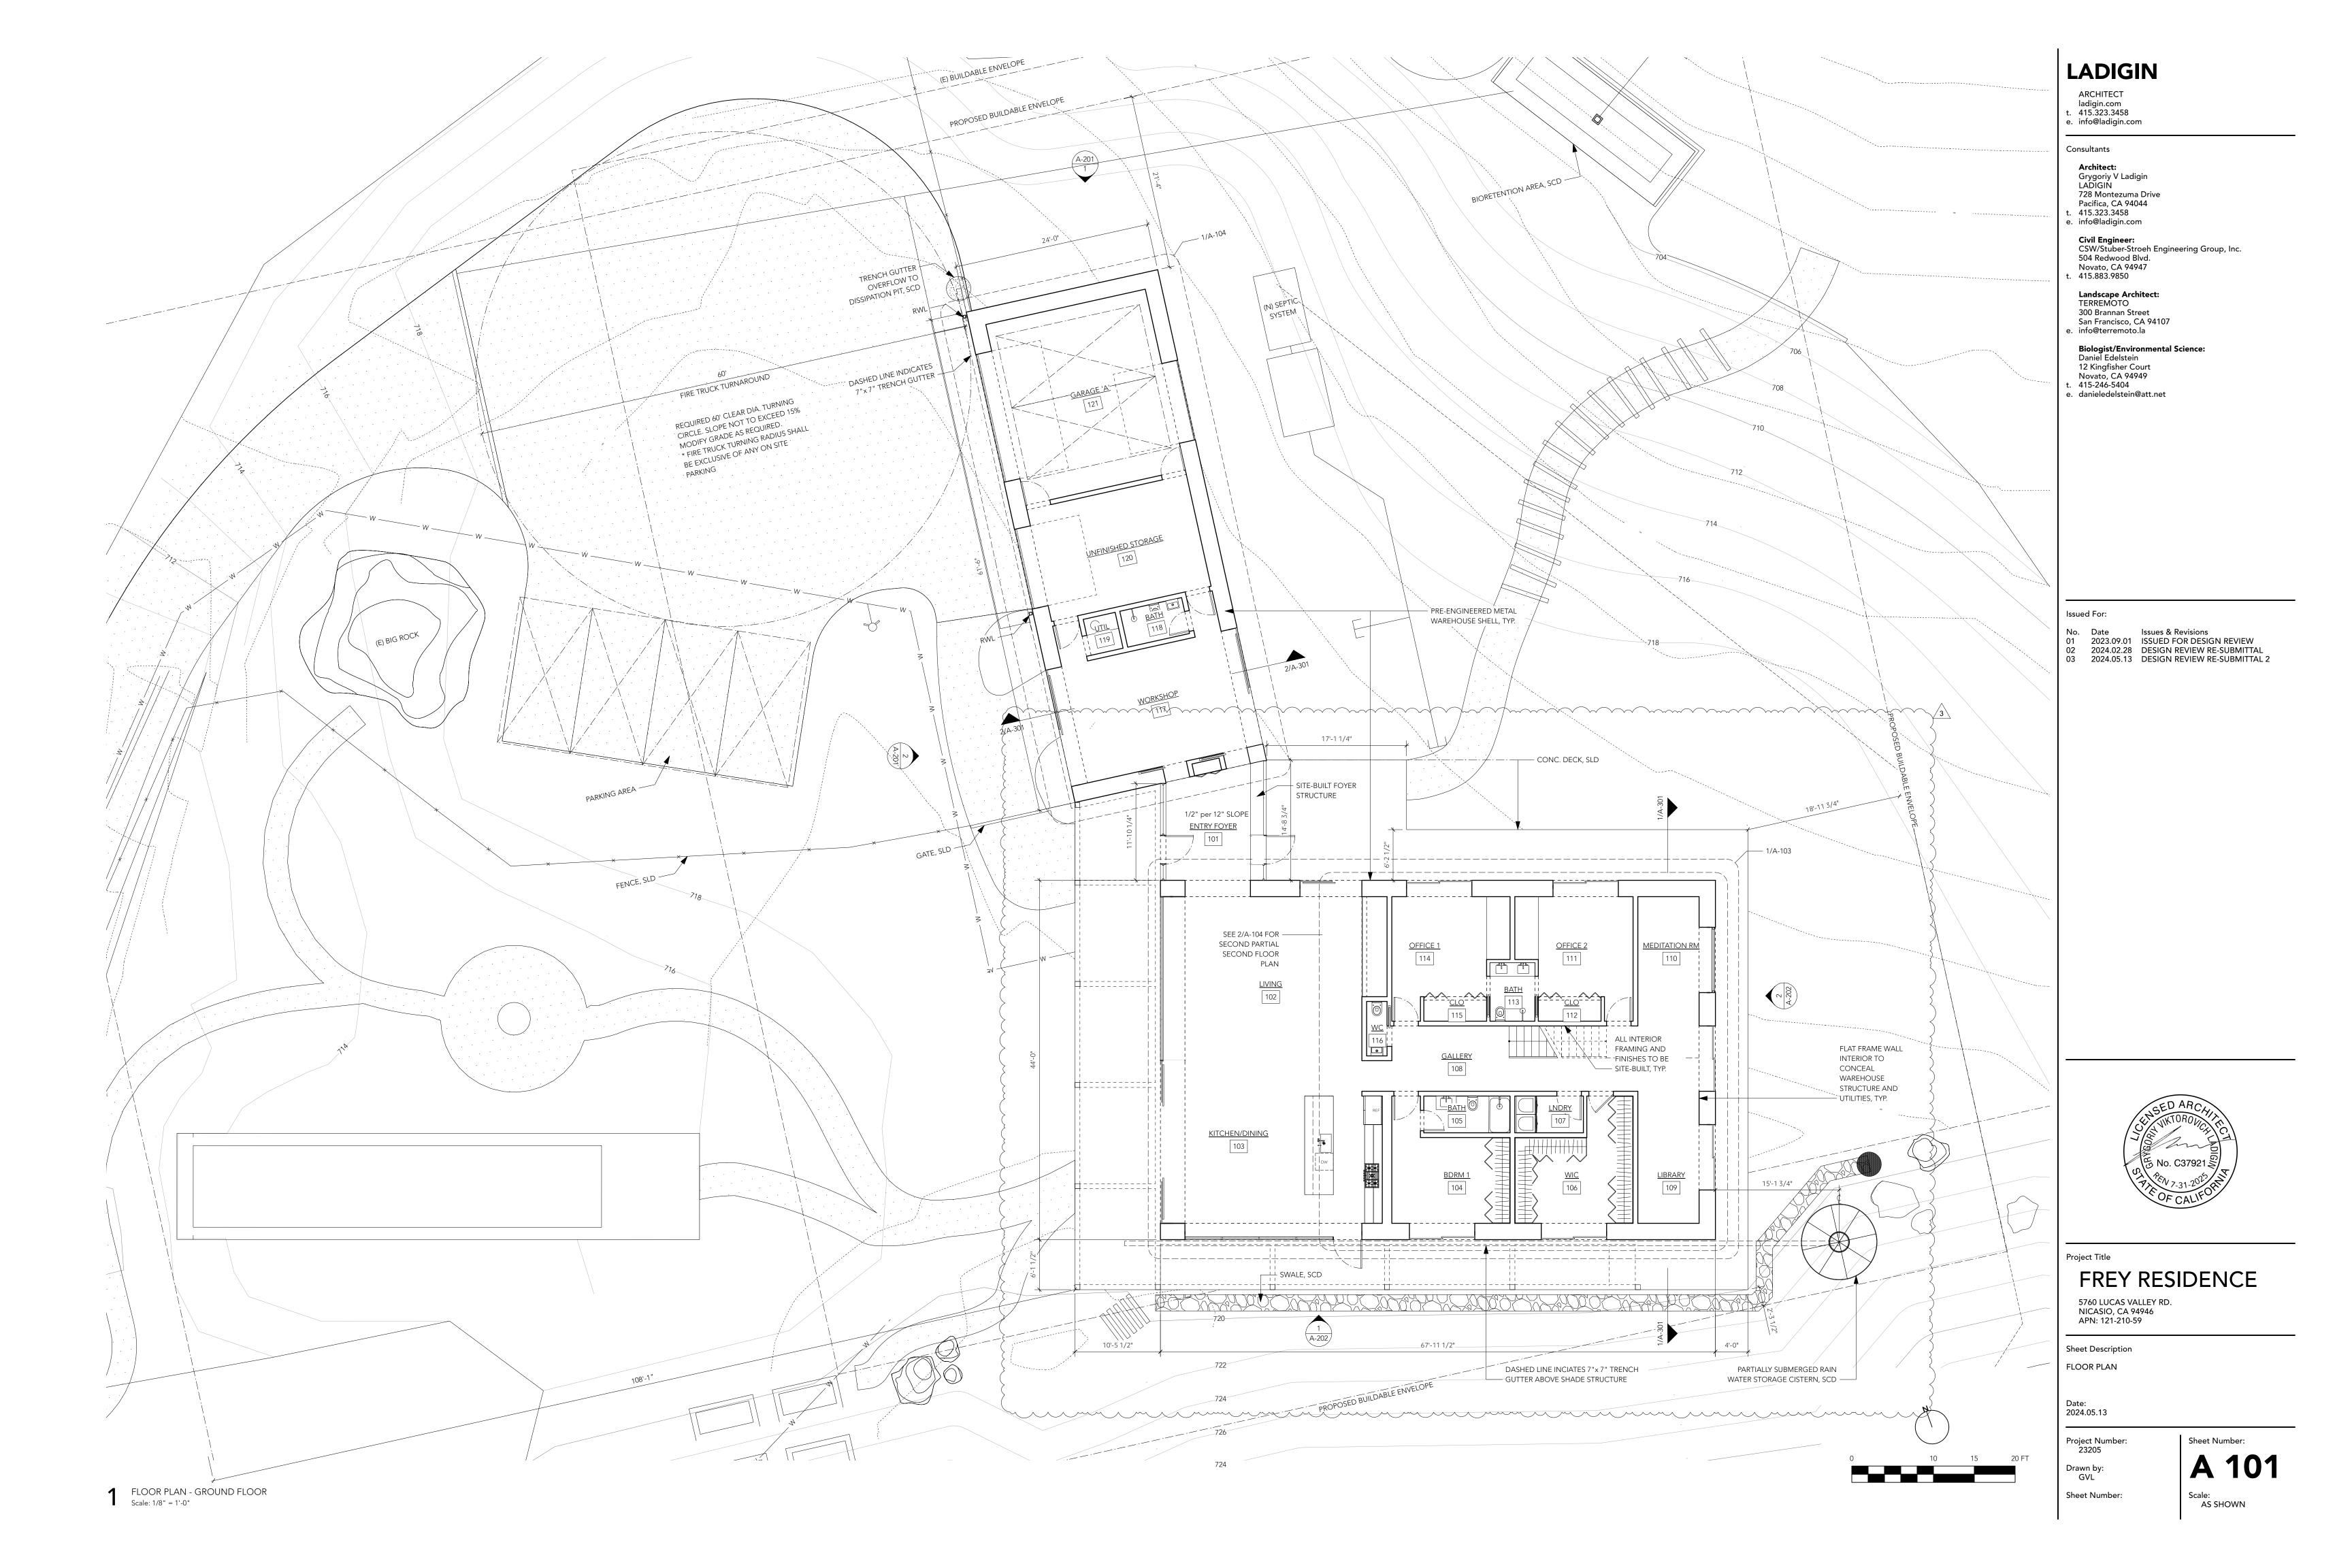Sheet Number: Scale: AS SHOWN

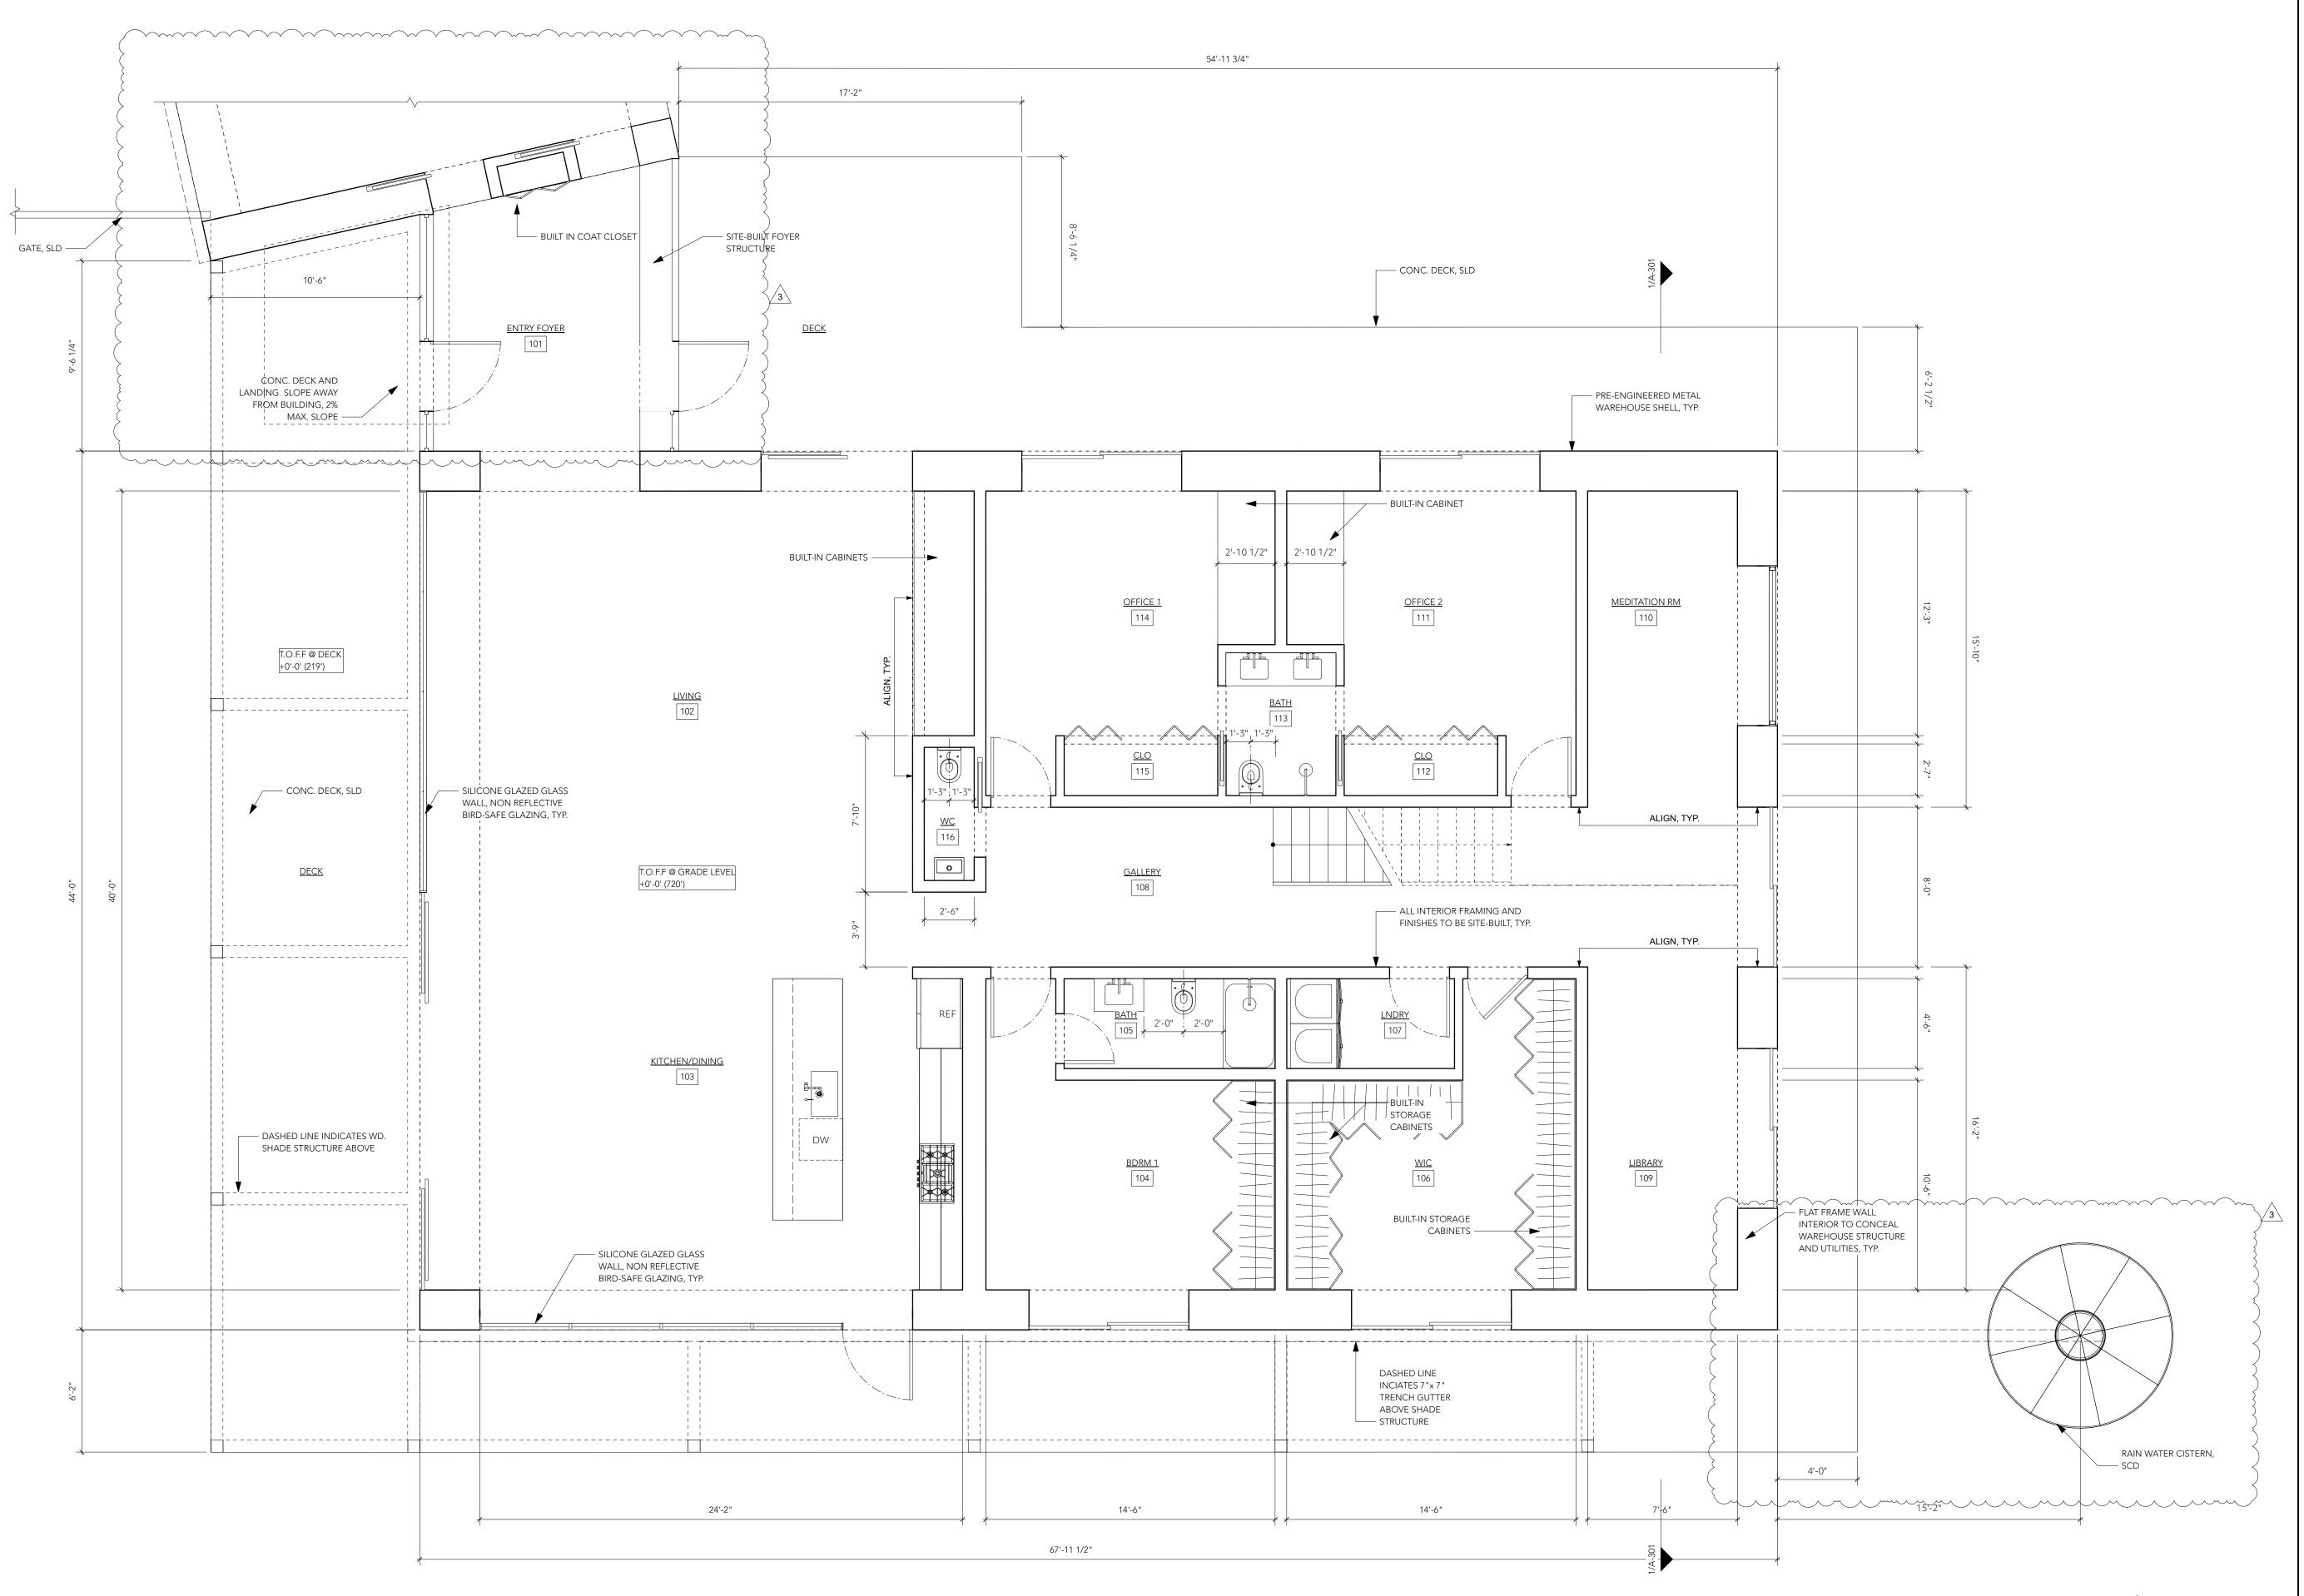

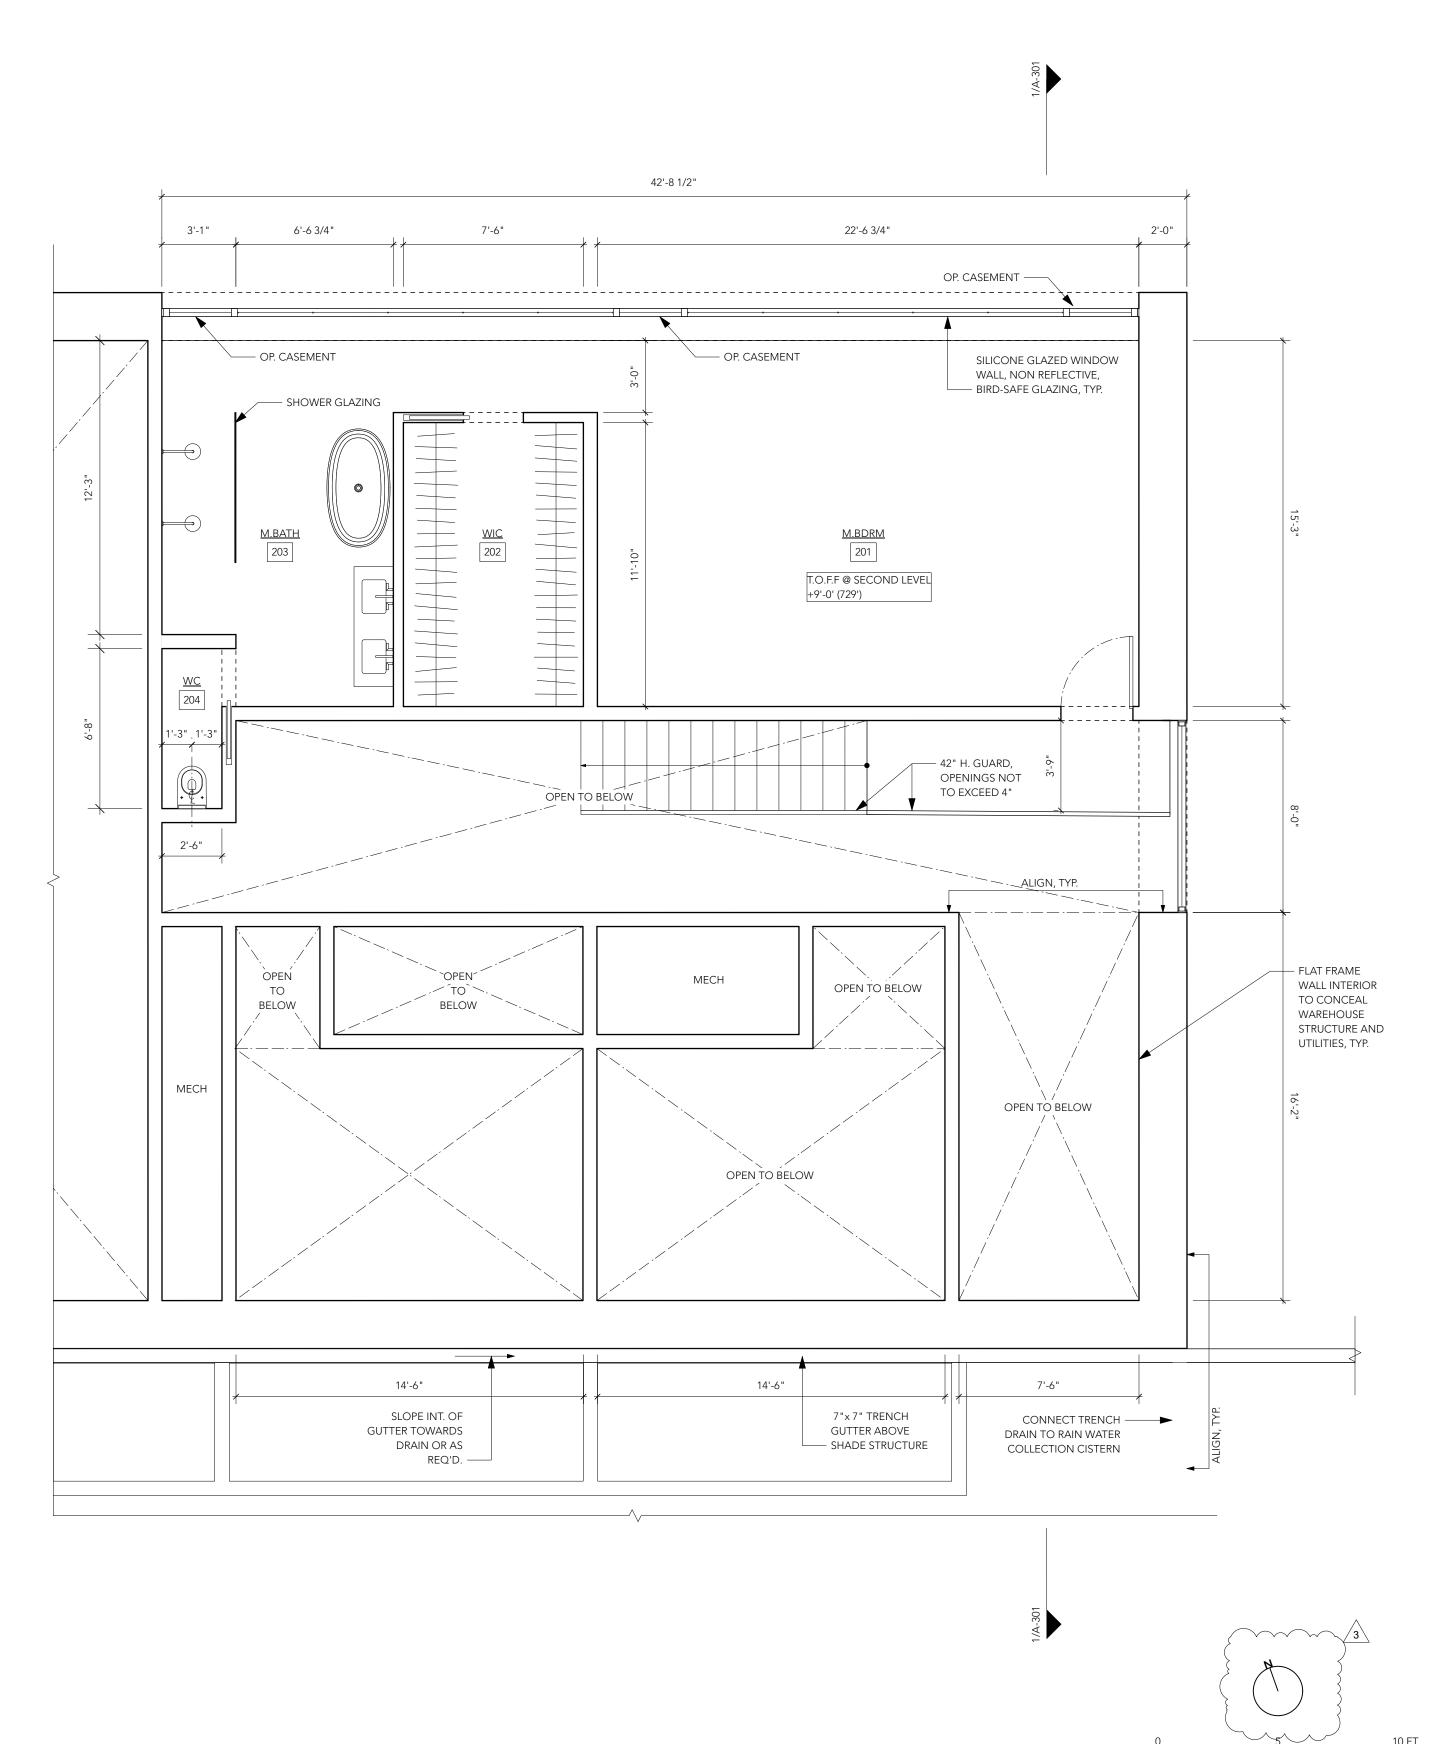

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FREY RESIDENCE

Sheet Number:

Scale: AS SHOWN

5760 LUCAS VALLEY RD. NICASIO, CA 94946 APN: 121-210-59

Sheet Description

PARTIAL FLOOR PLAN (GARAGE) PARTIAL SECOND FLOOR PLAN (RESIDENCE)

Date: 2024.05.13

Project Number: 23205

Drawn by: GVL Sheet Number:

PARTIAL SECOND FLOOR PLAN Scale: 1/4" = 1'-0"




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Issued For:

No. Date Issues & Revisions
01 2023.09.01 ISSUED FOR DESIGN REVIEW
02 2024.02.28 DESIGN REVIEW RE-SUBMITTAL
03 2024.05.13 DESIGN REVIEW RE-SUBMITTAL 2



Project Title

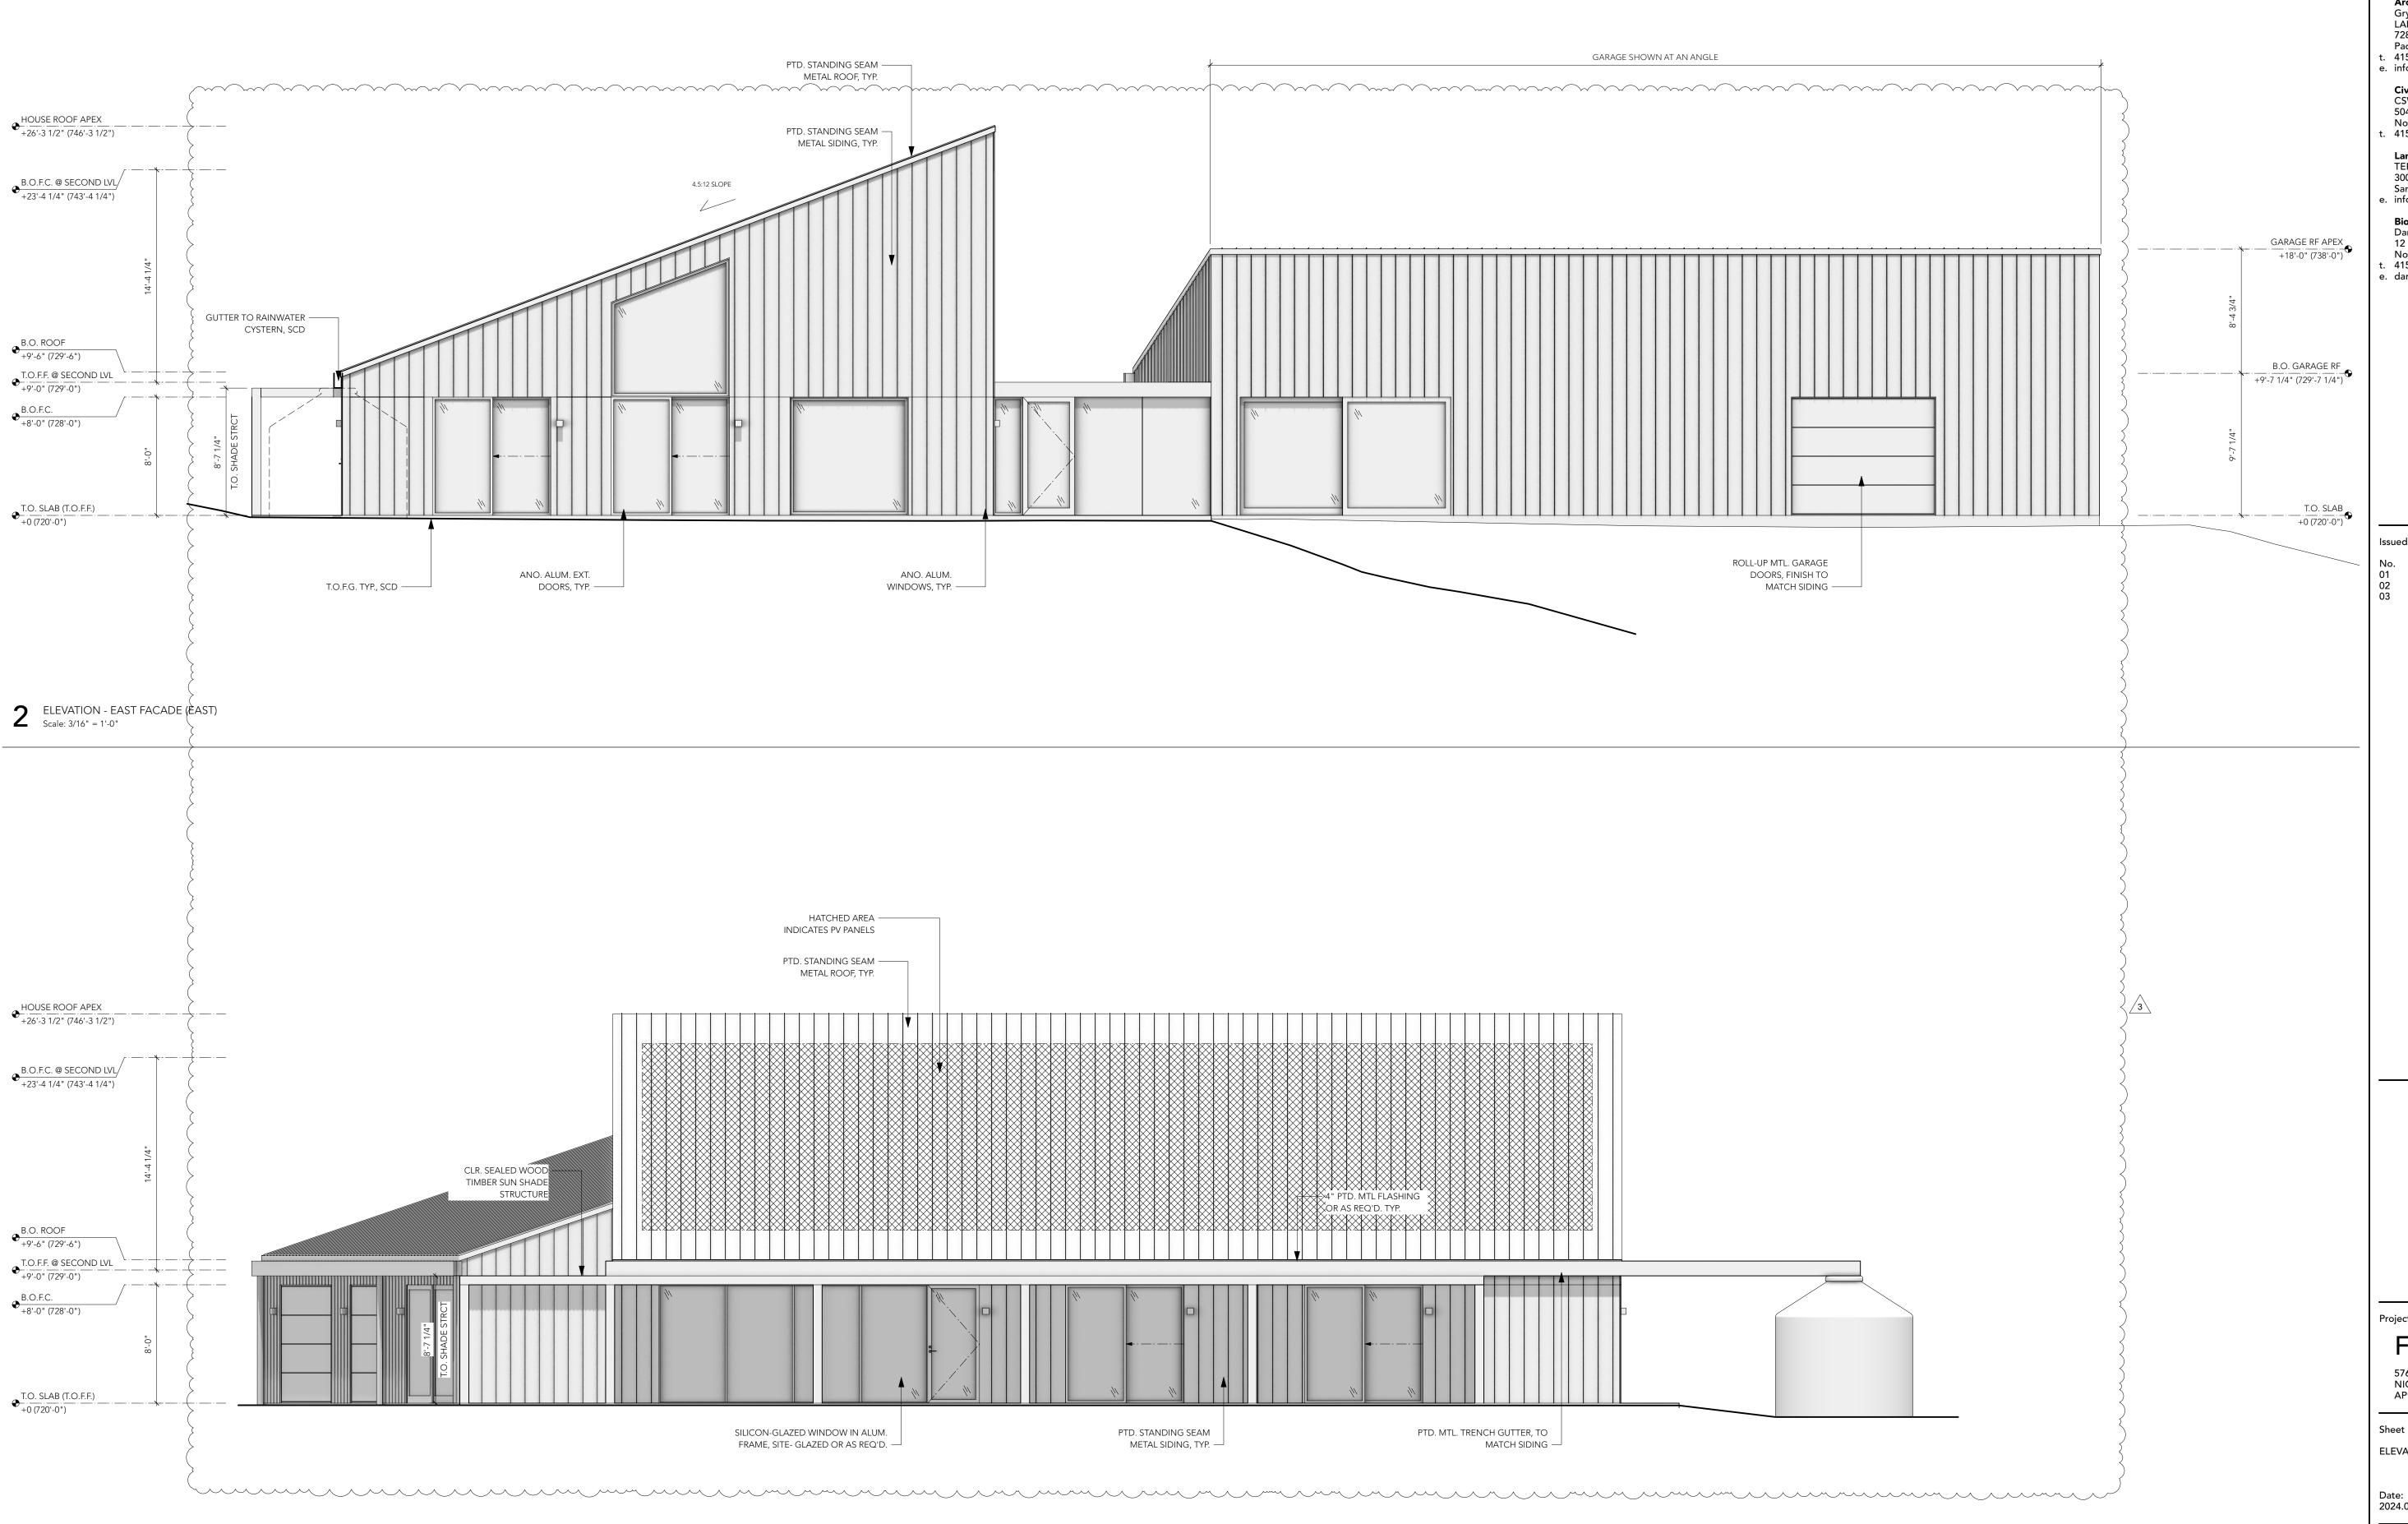FREY RESIDENCE

5760 LUCAS VALLEY RD. NICASIO, CA 94946 APN: 121-210-59

Sheet Description


ELEVATIONS


Date: 2024.05.13

Project Number: 23205

Drawn by: GVL Sheet Number:

Sheet Number: Scale: AS SHOWN

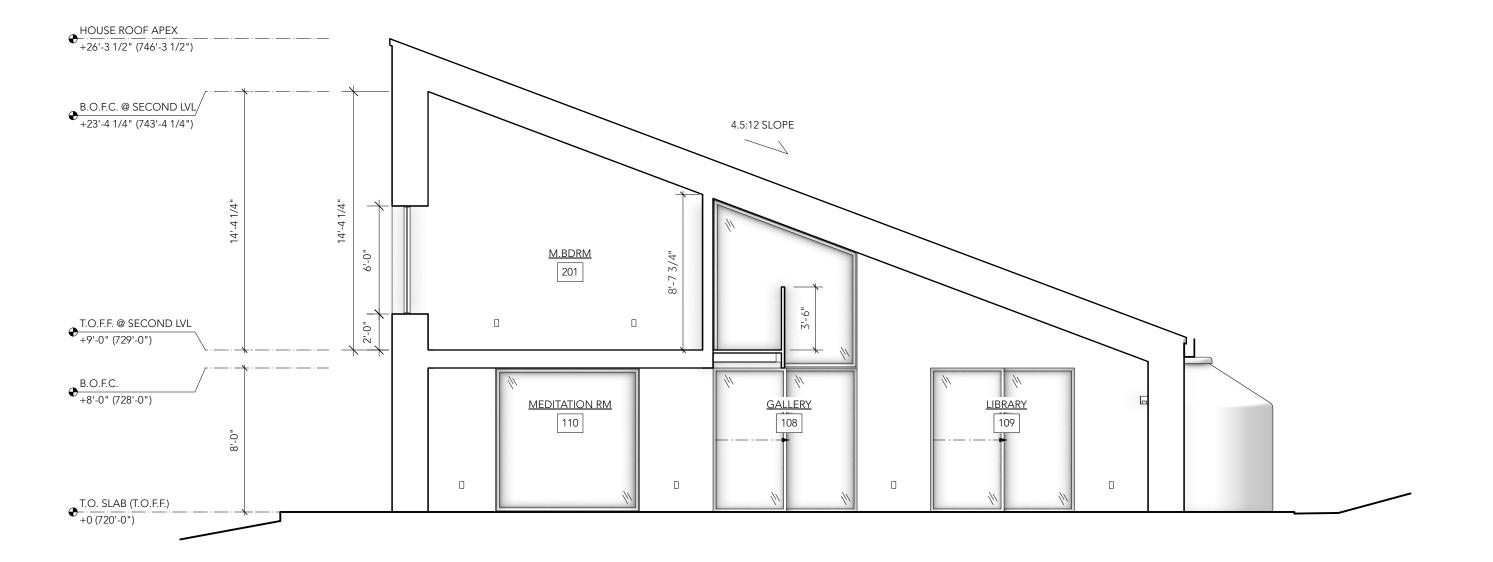

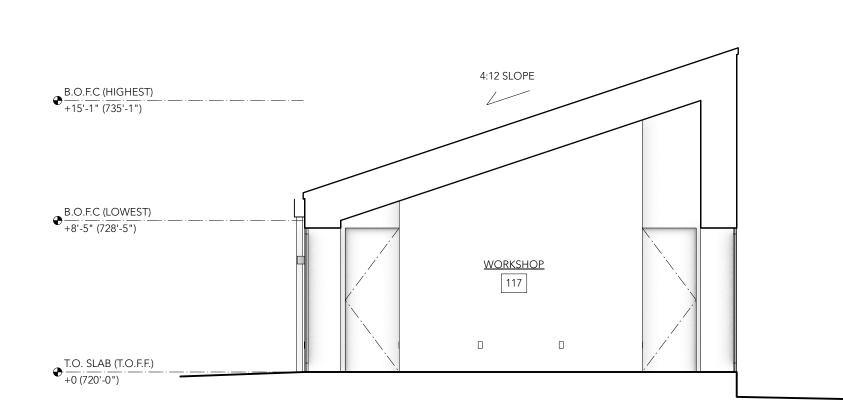

CROSS SECTION - A Scale: 3/16" = 1'-0"

2 CROSS SECTION - B Scale: 3/16" = 1'-0"

LADIGIN

ARCHITECT ladigin.com t. 415.323.3458 e. info@ladigin.com

Consultants

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LADIGIN
728 Montezuma Drive
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t. 415.323.3458
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Civil Engineer:
CSW/Stuber-Stroeh Engineering Group, Inc.
504 Redwood Blvd.
Novato, CA 94947
t. 415.883.9850

Landscape Architect: TERREMOTO 300 Brannan Street

San Francisco, CA 94107 e. info@terremoto.la

Biologist/Environmental Science:
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Project Title

FREY RESIDENCE

5760 LUCAS VALLEY RD. NICASIO, CA 94946 APN: 121-210-59

Sheet Description

SECTIONS


Date: 2024.05.13


Project Number: 23205


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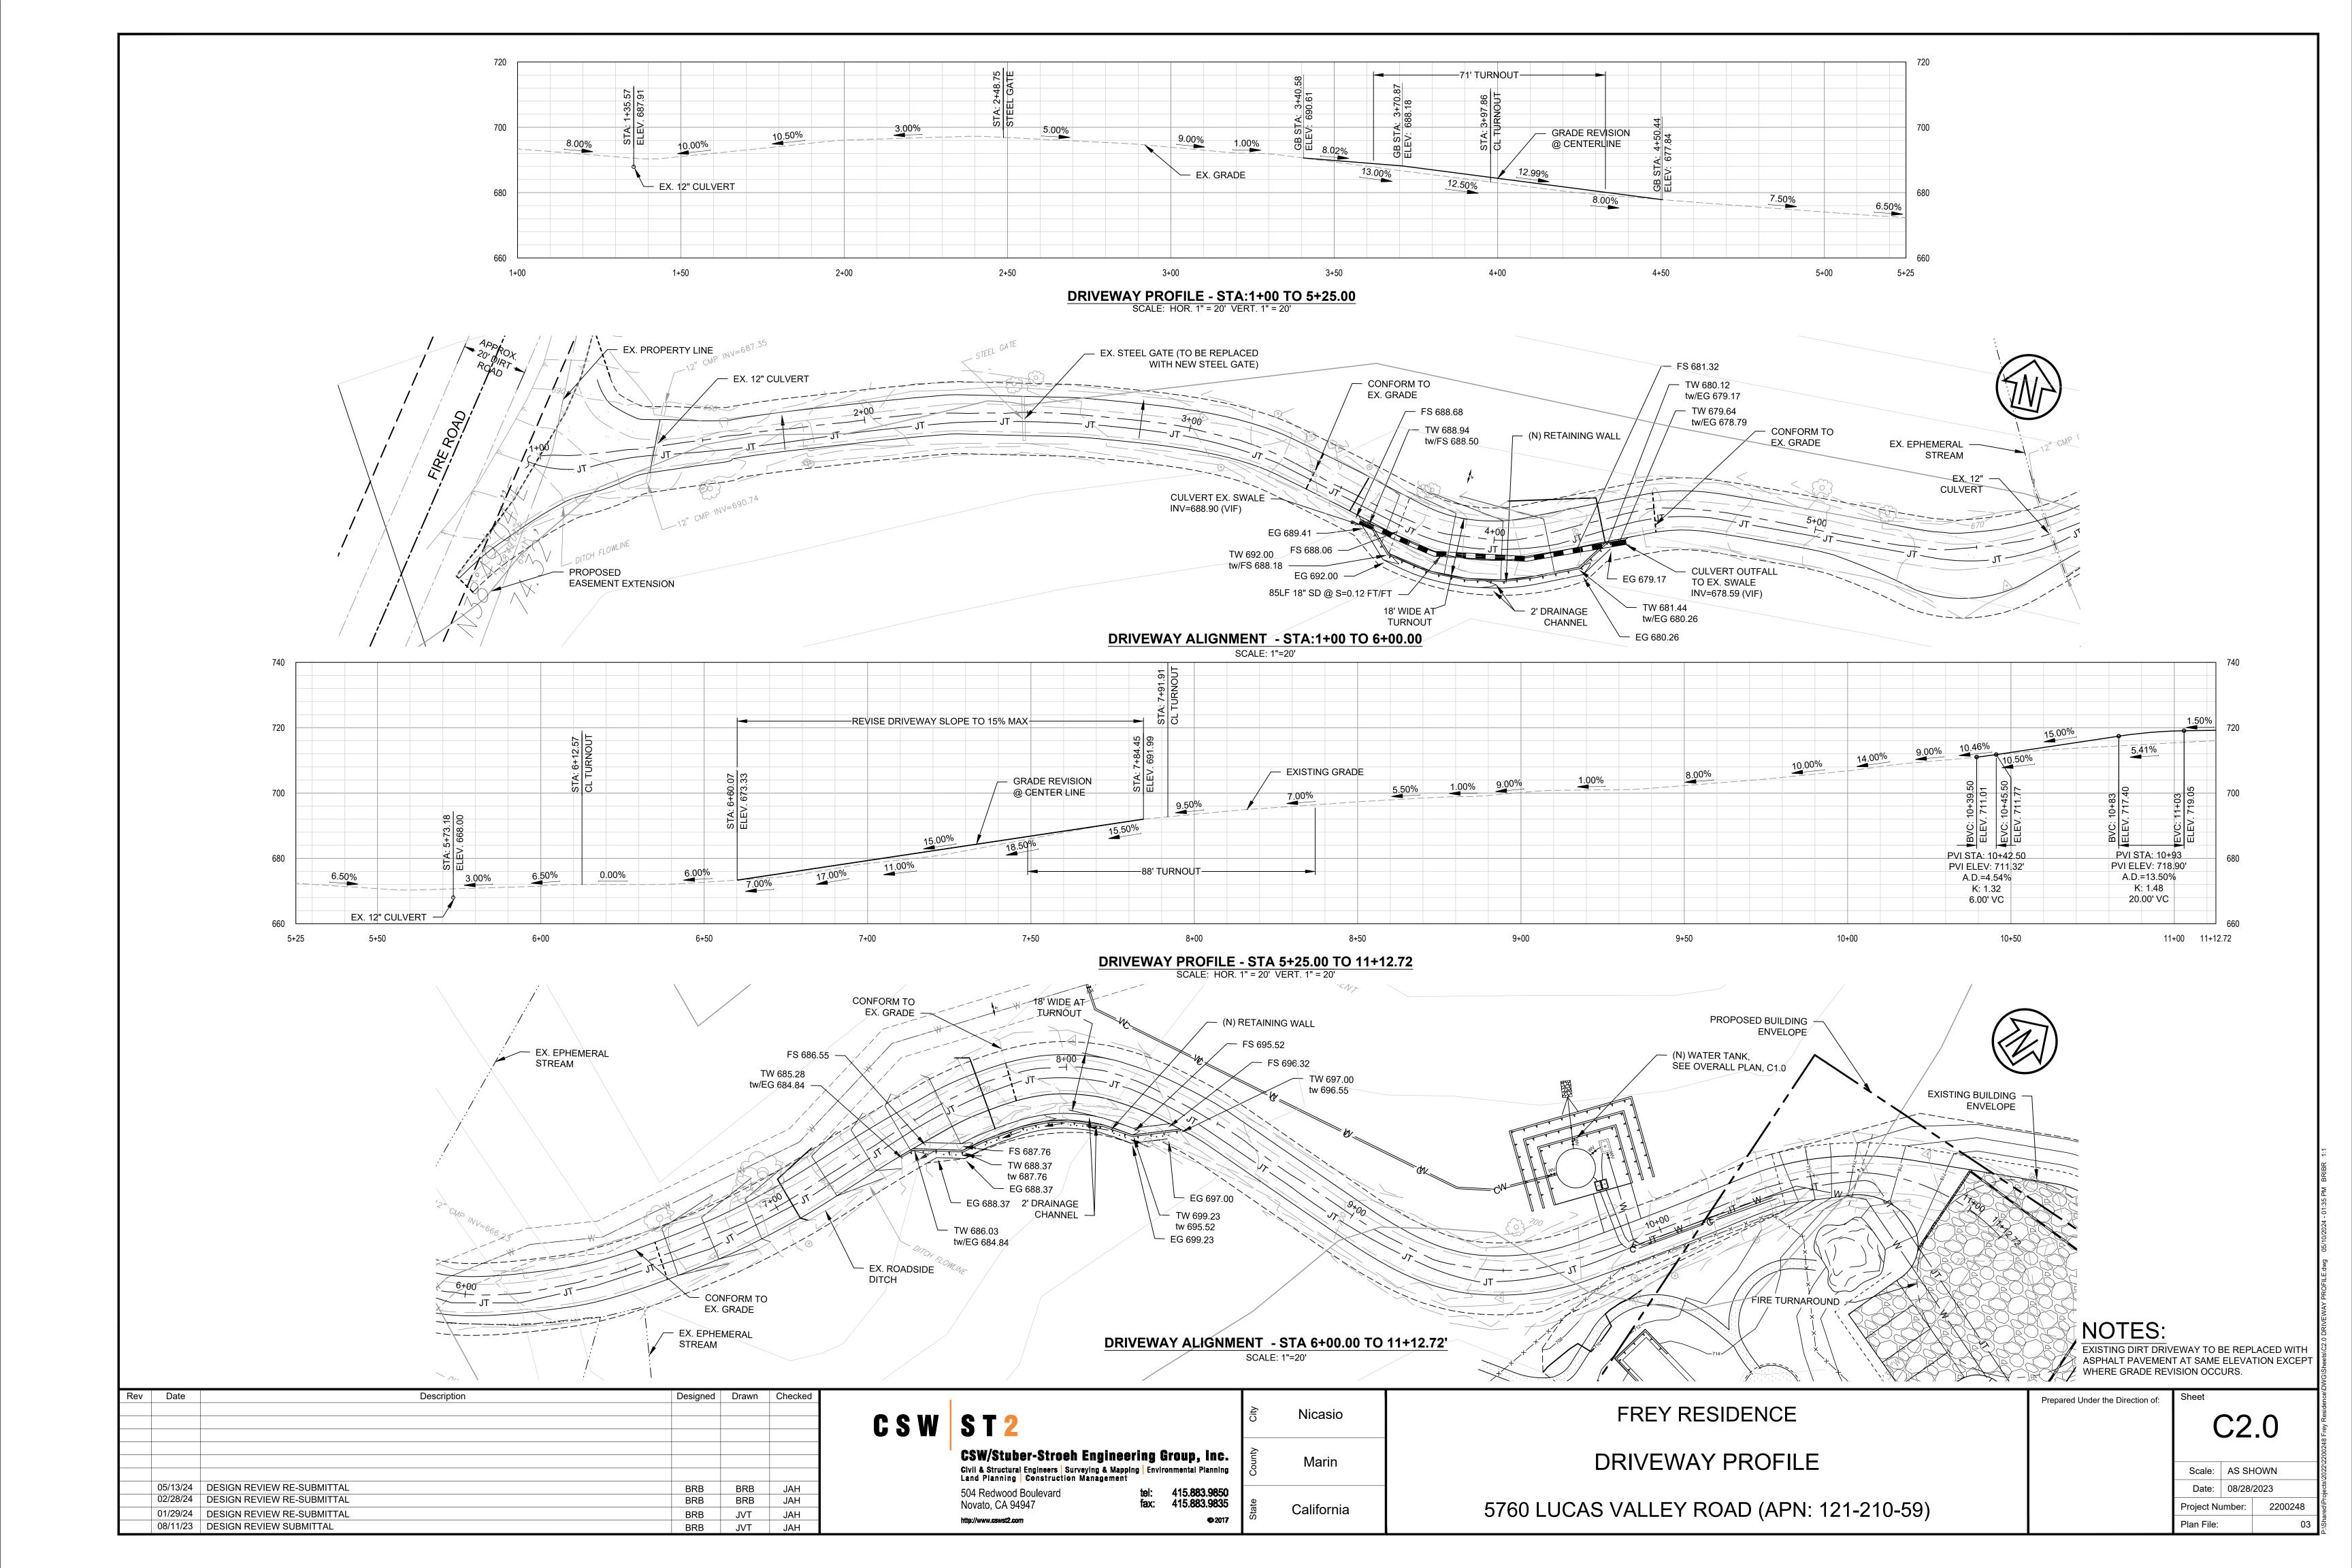
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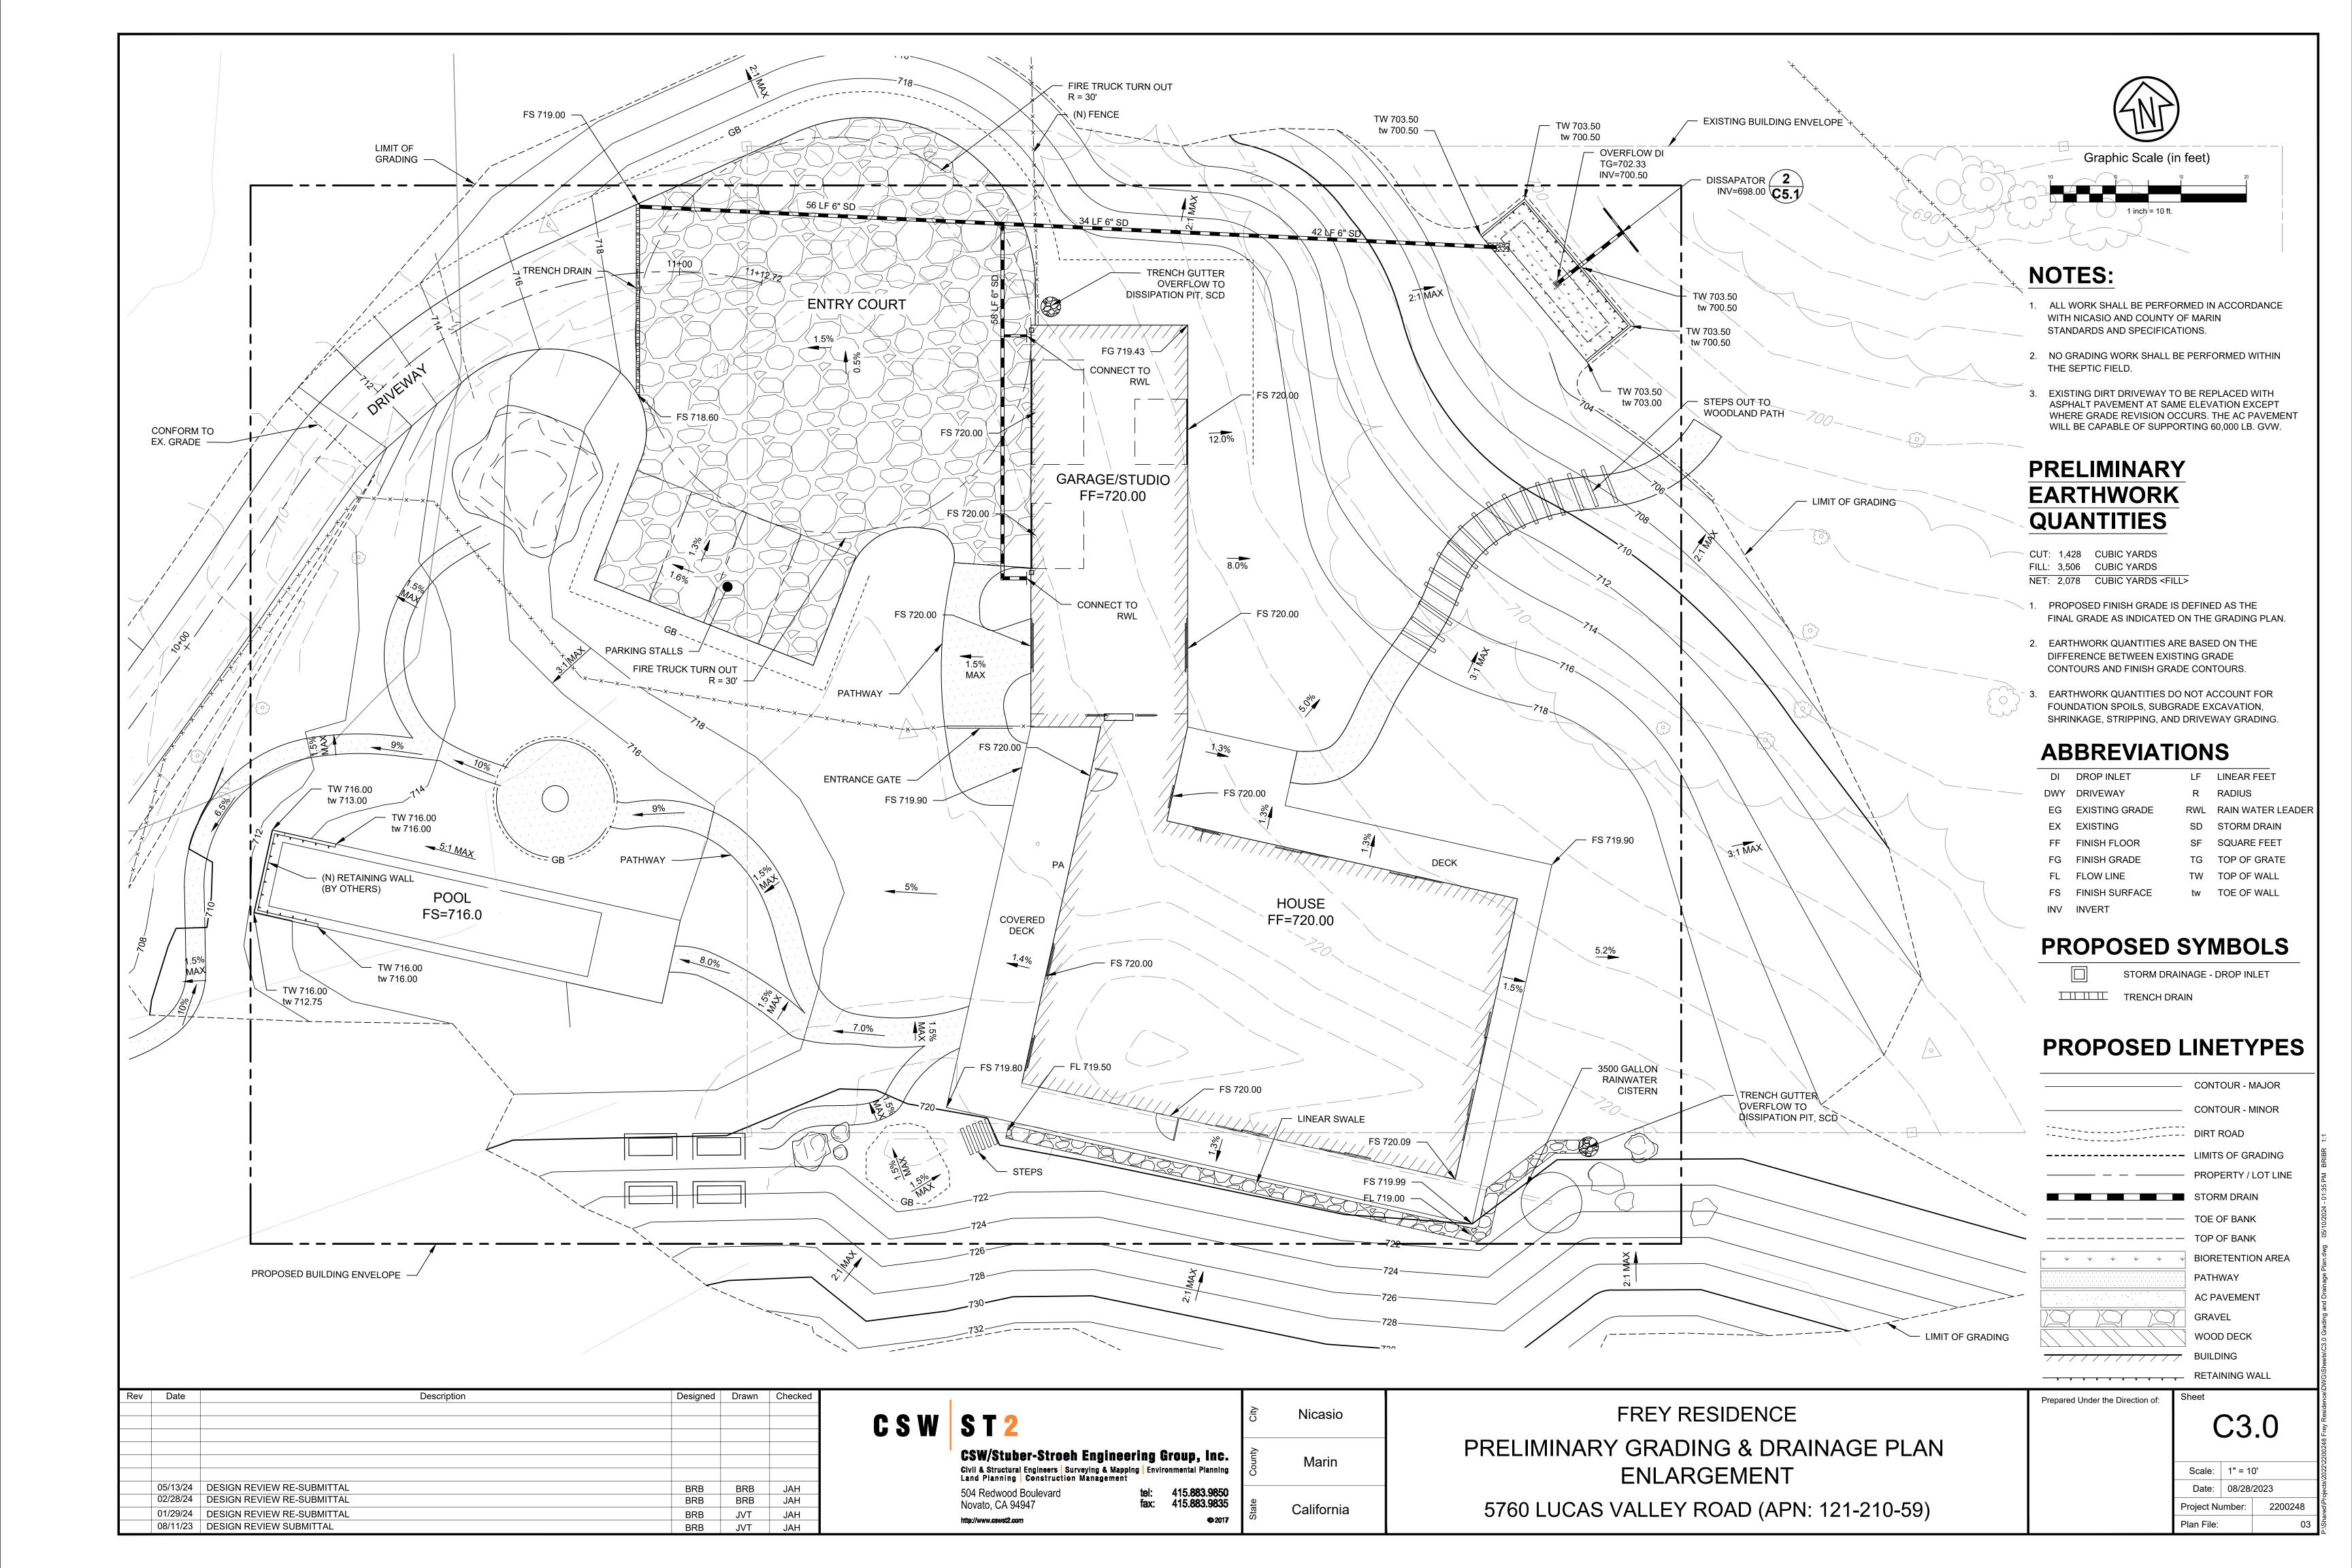
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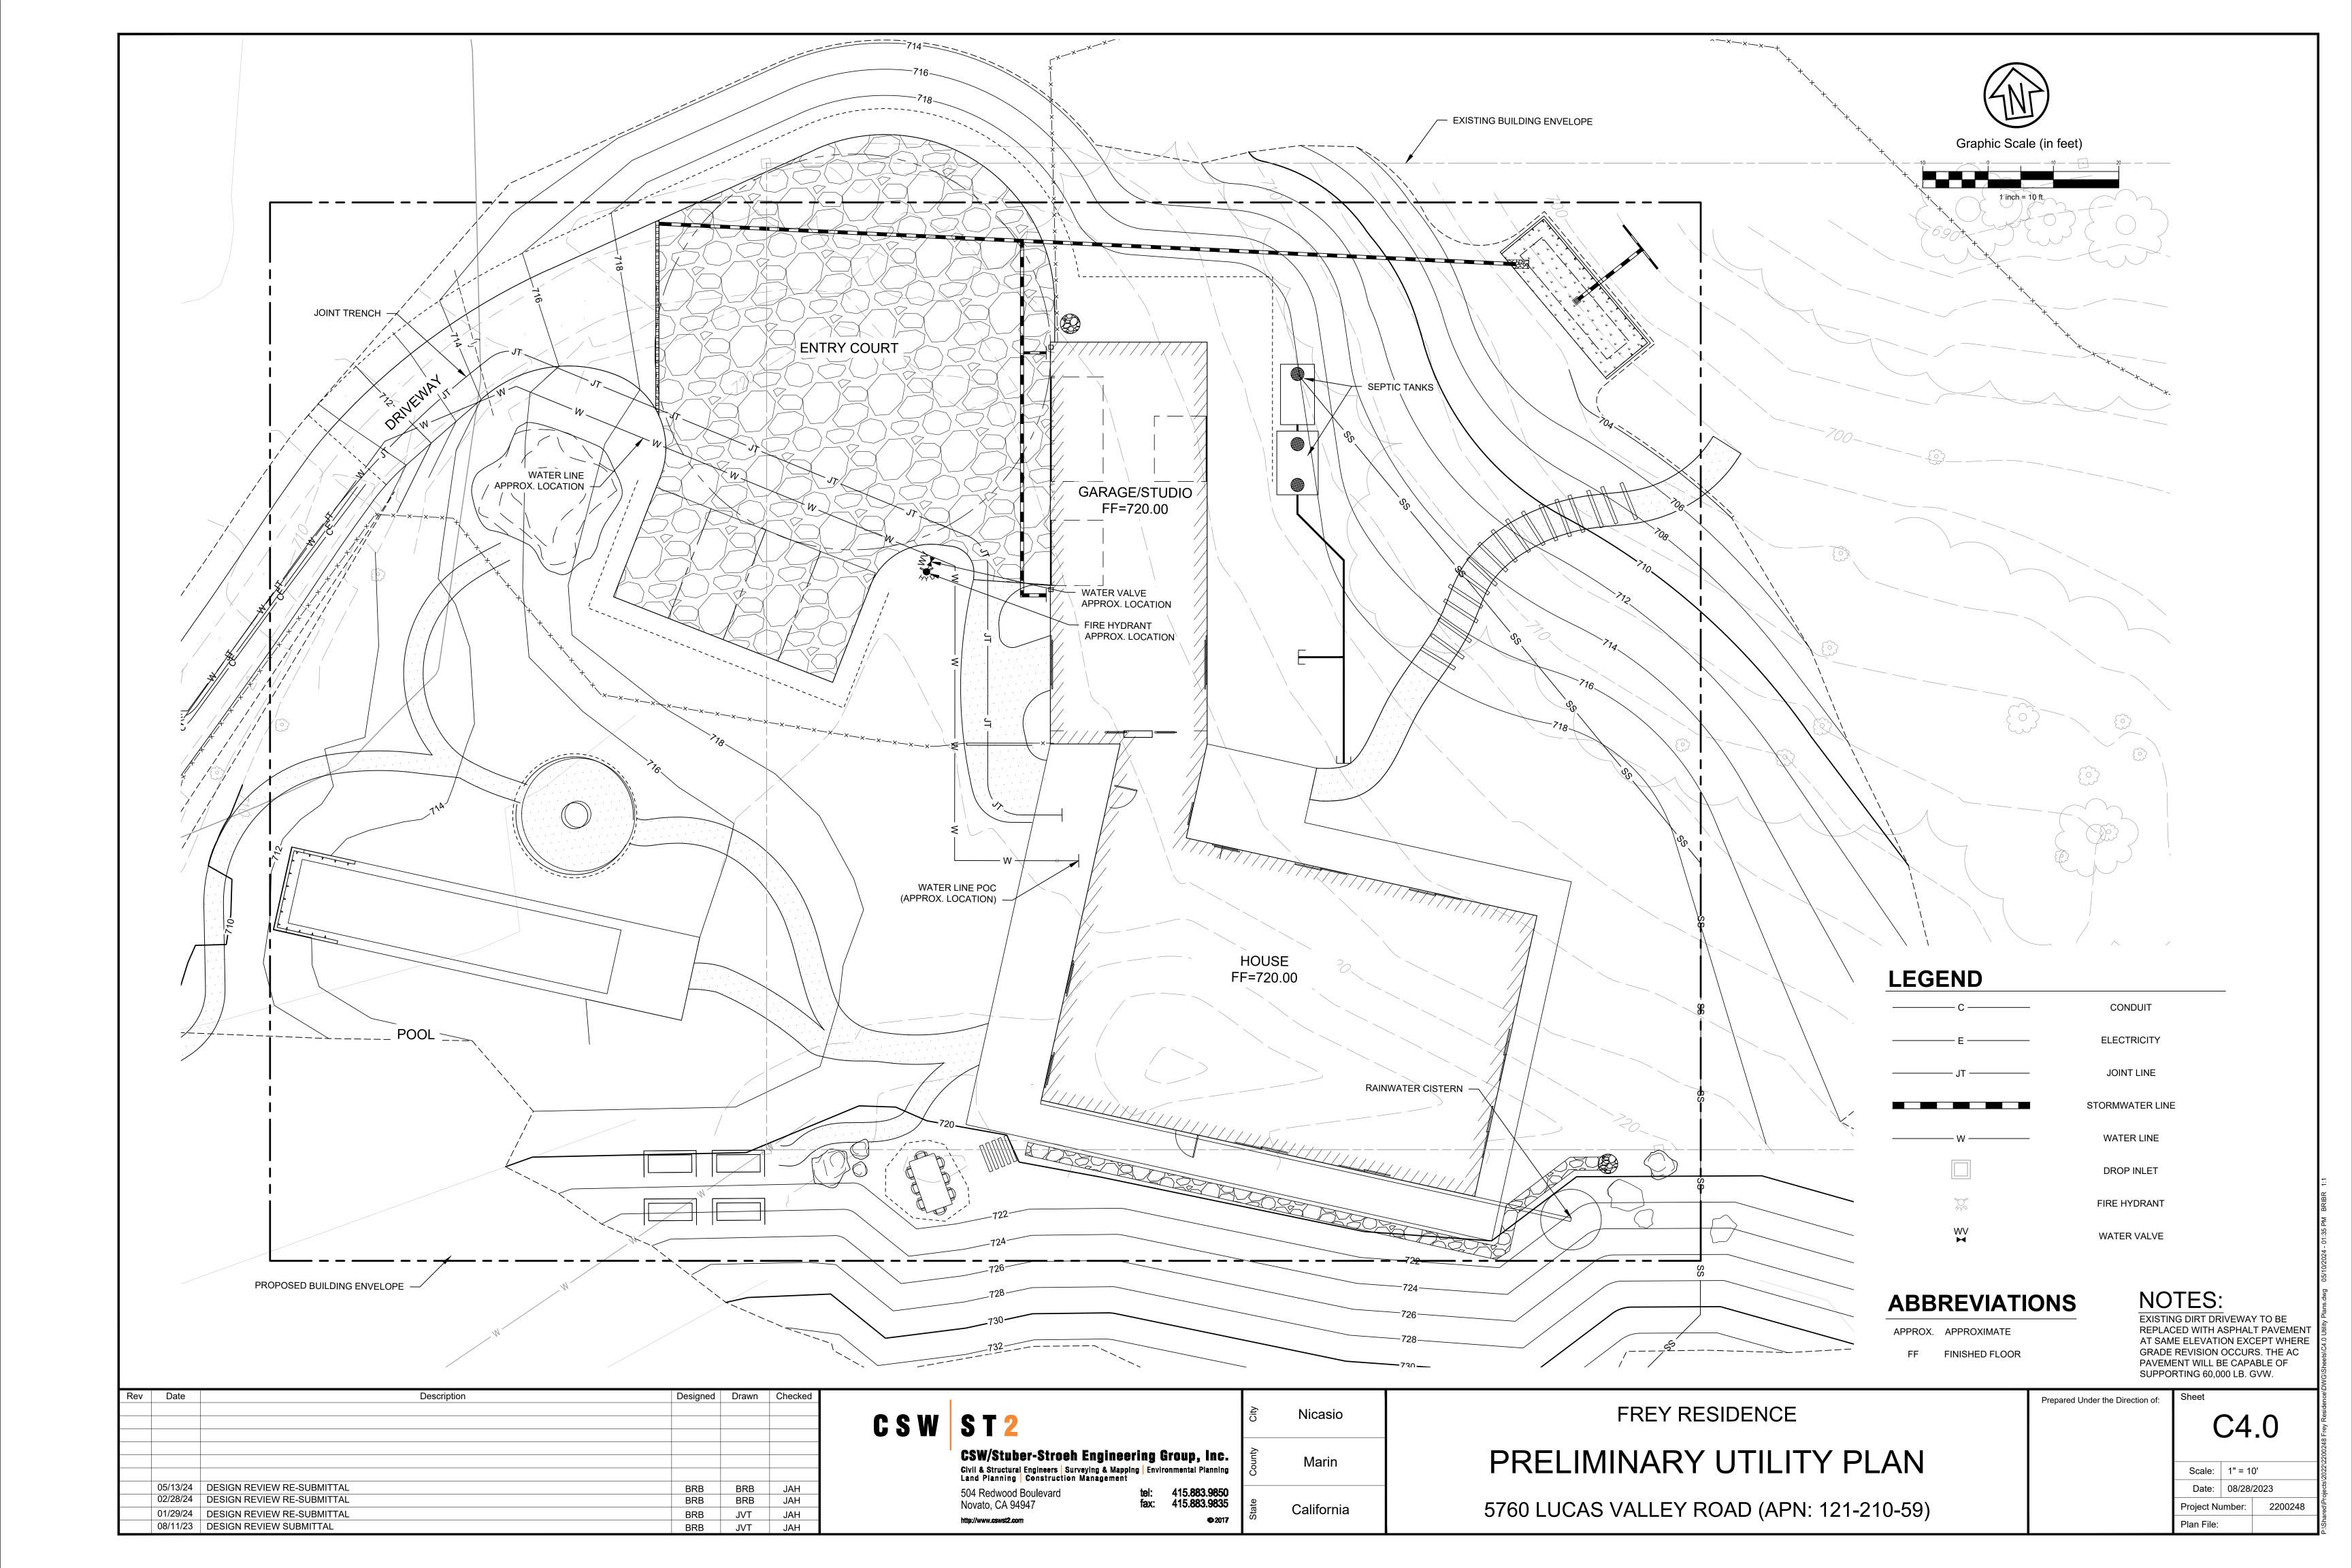








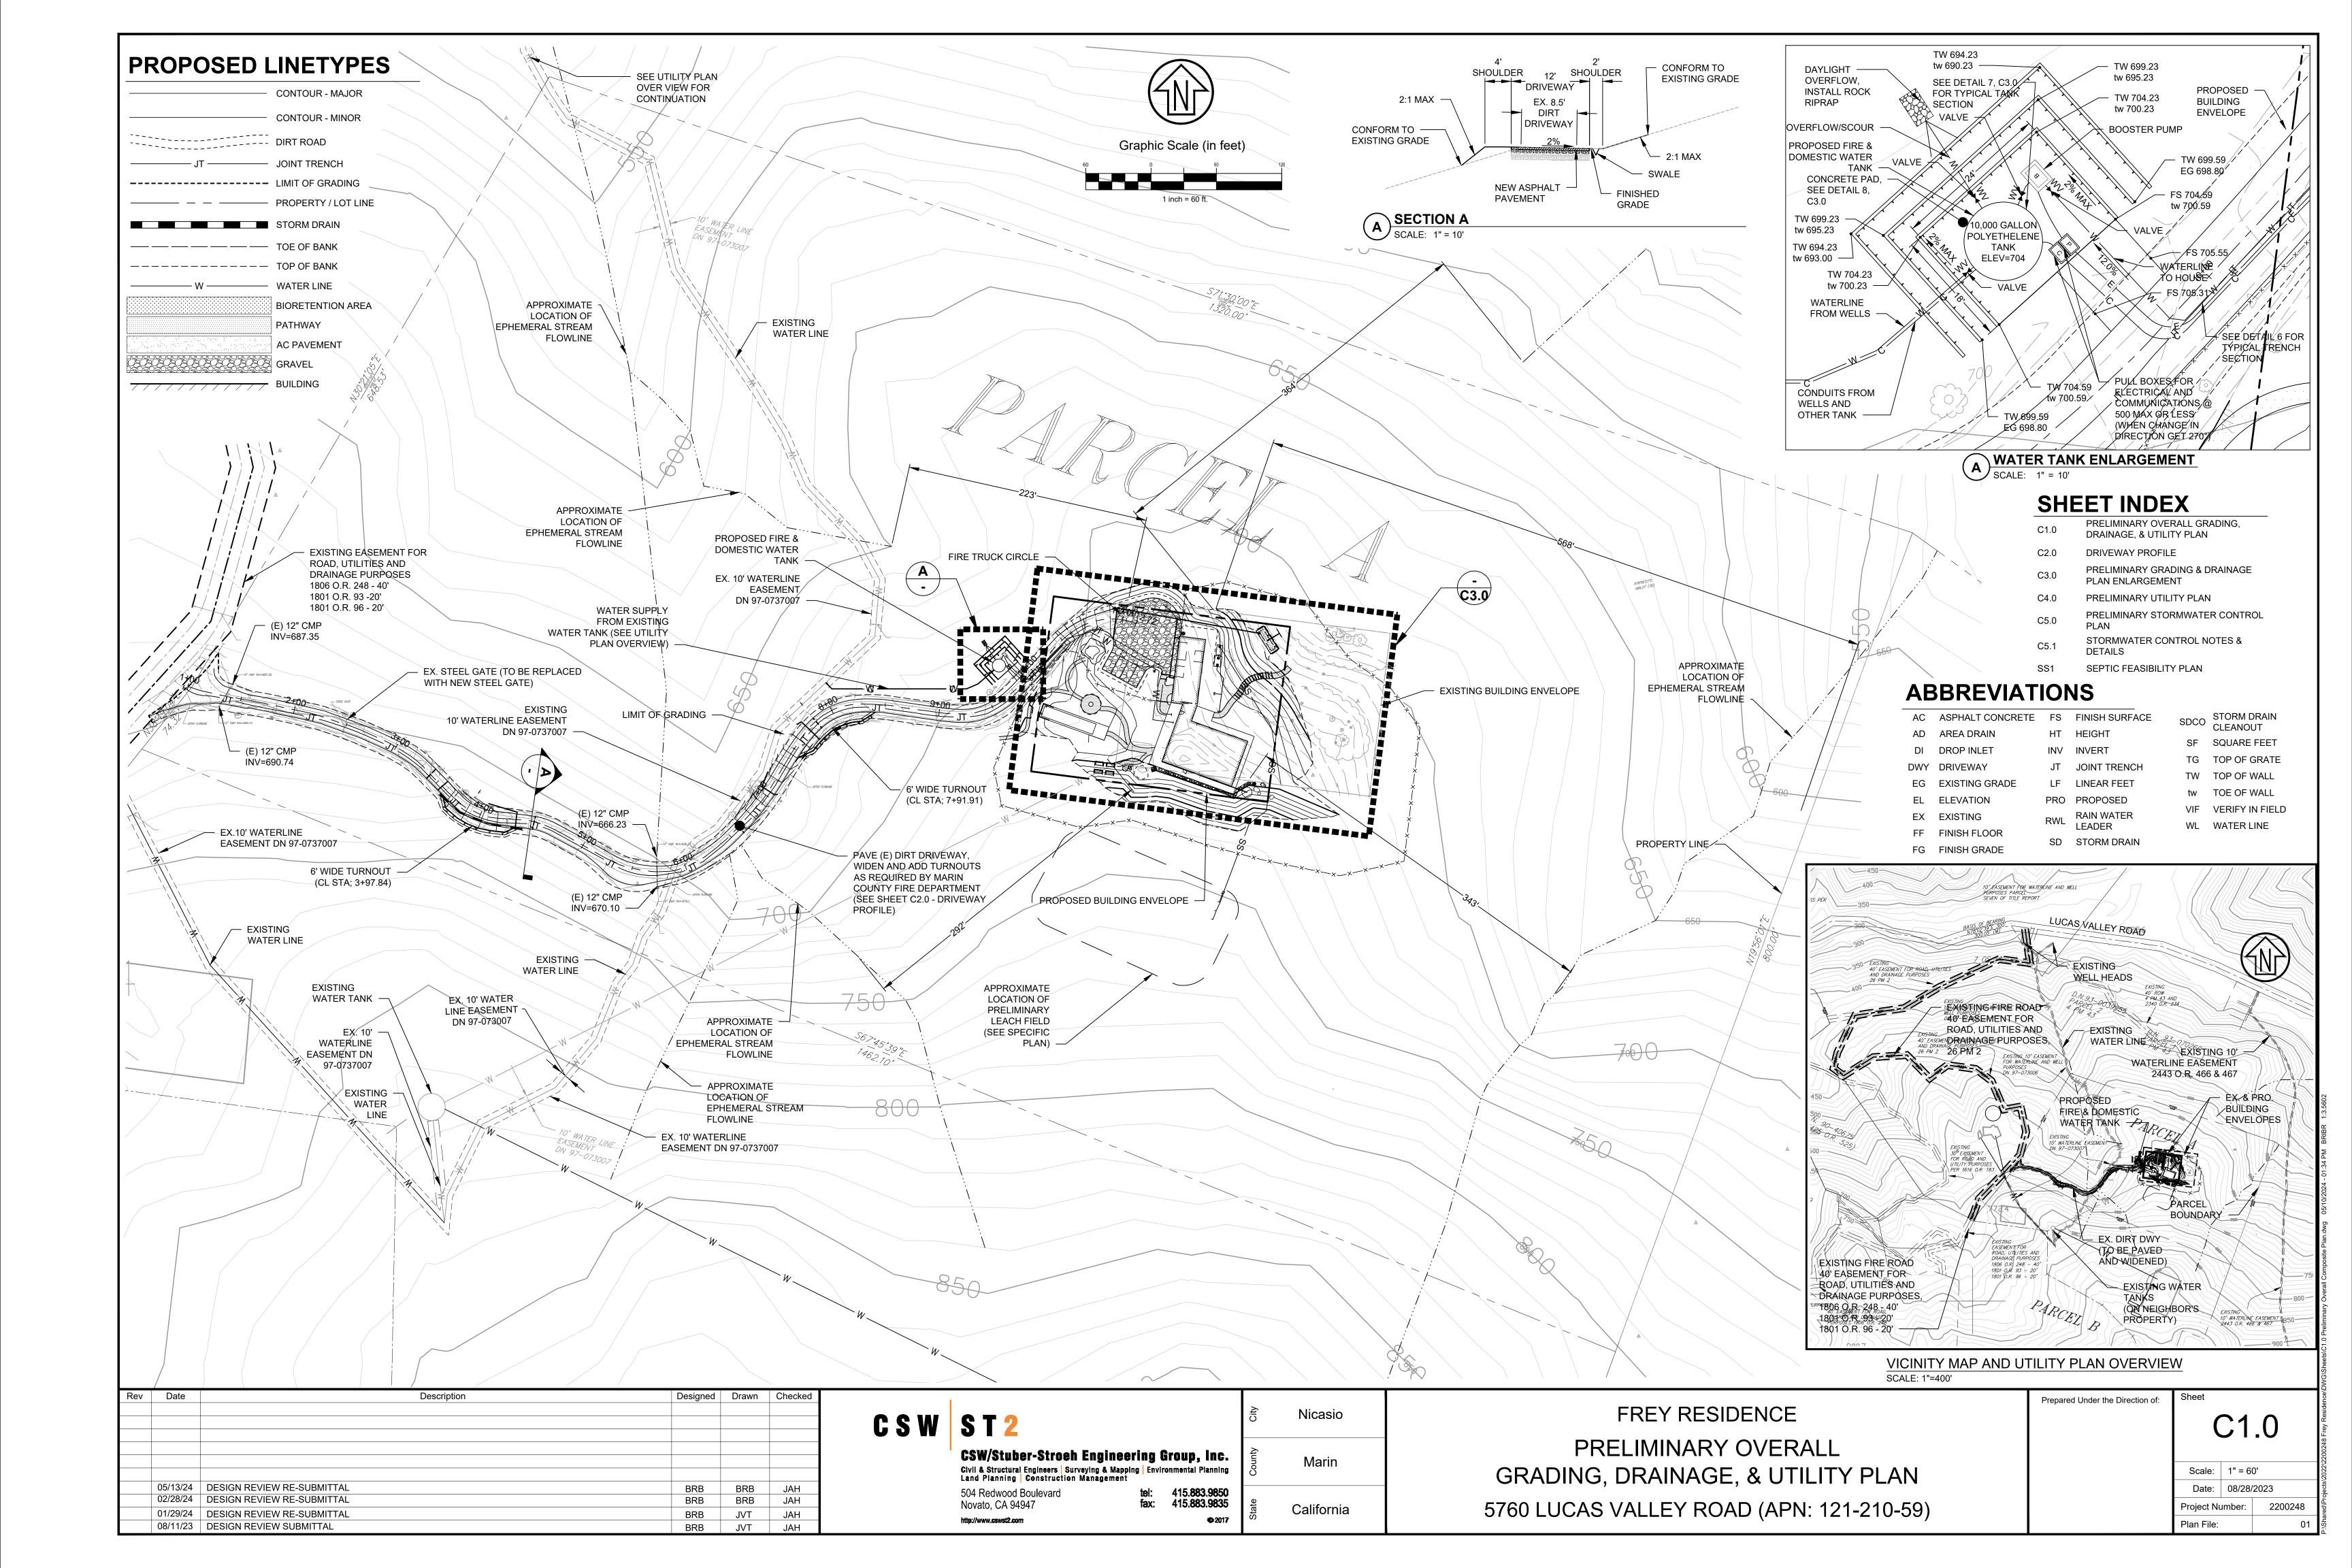

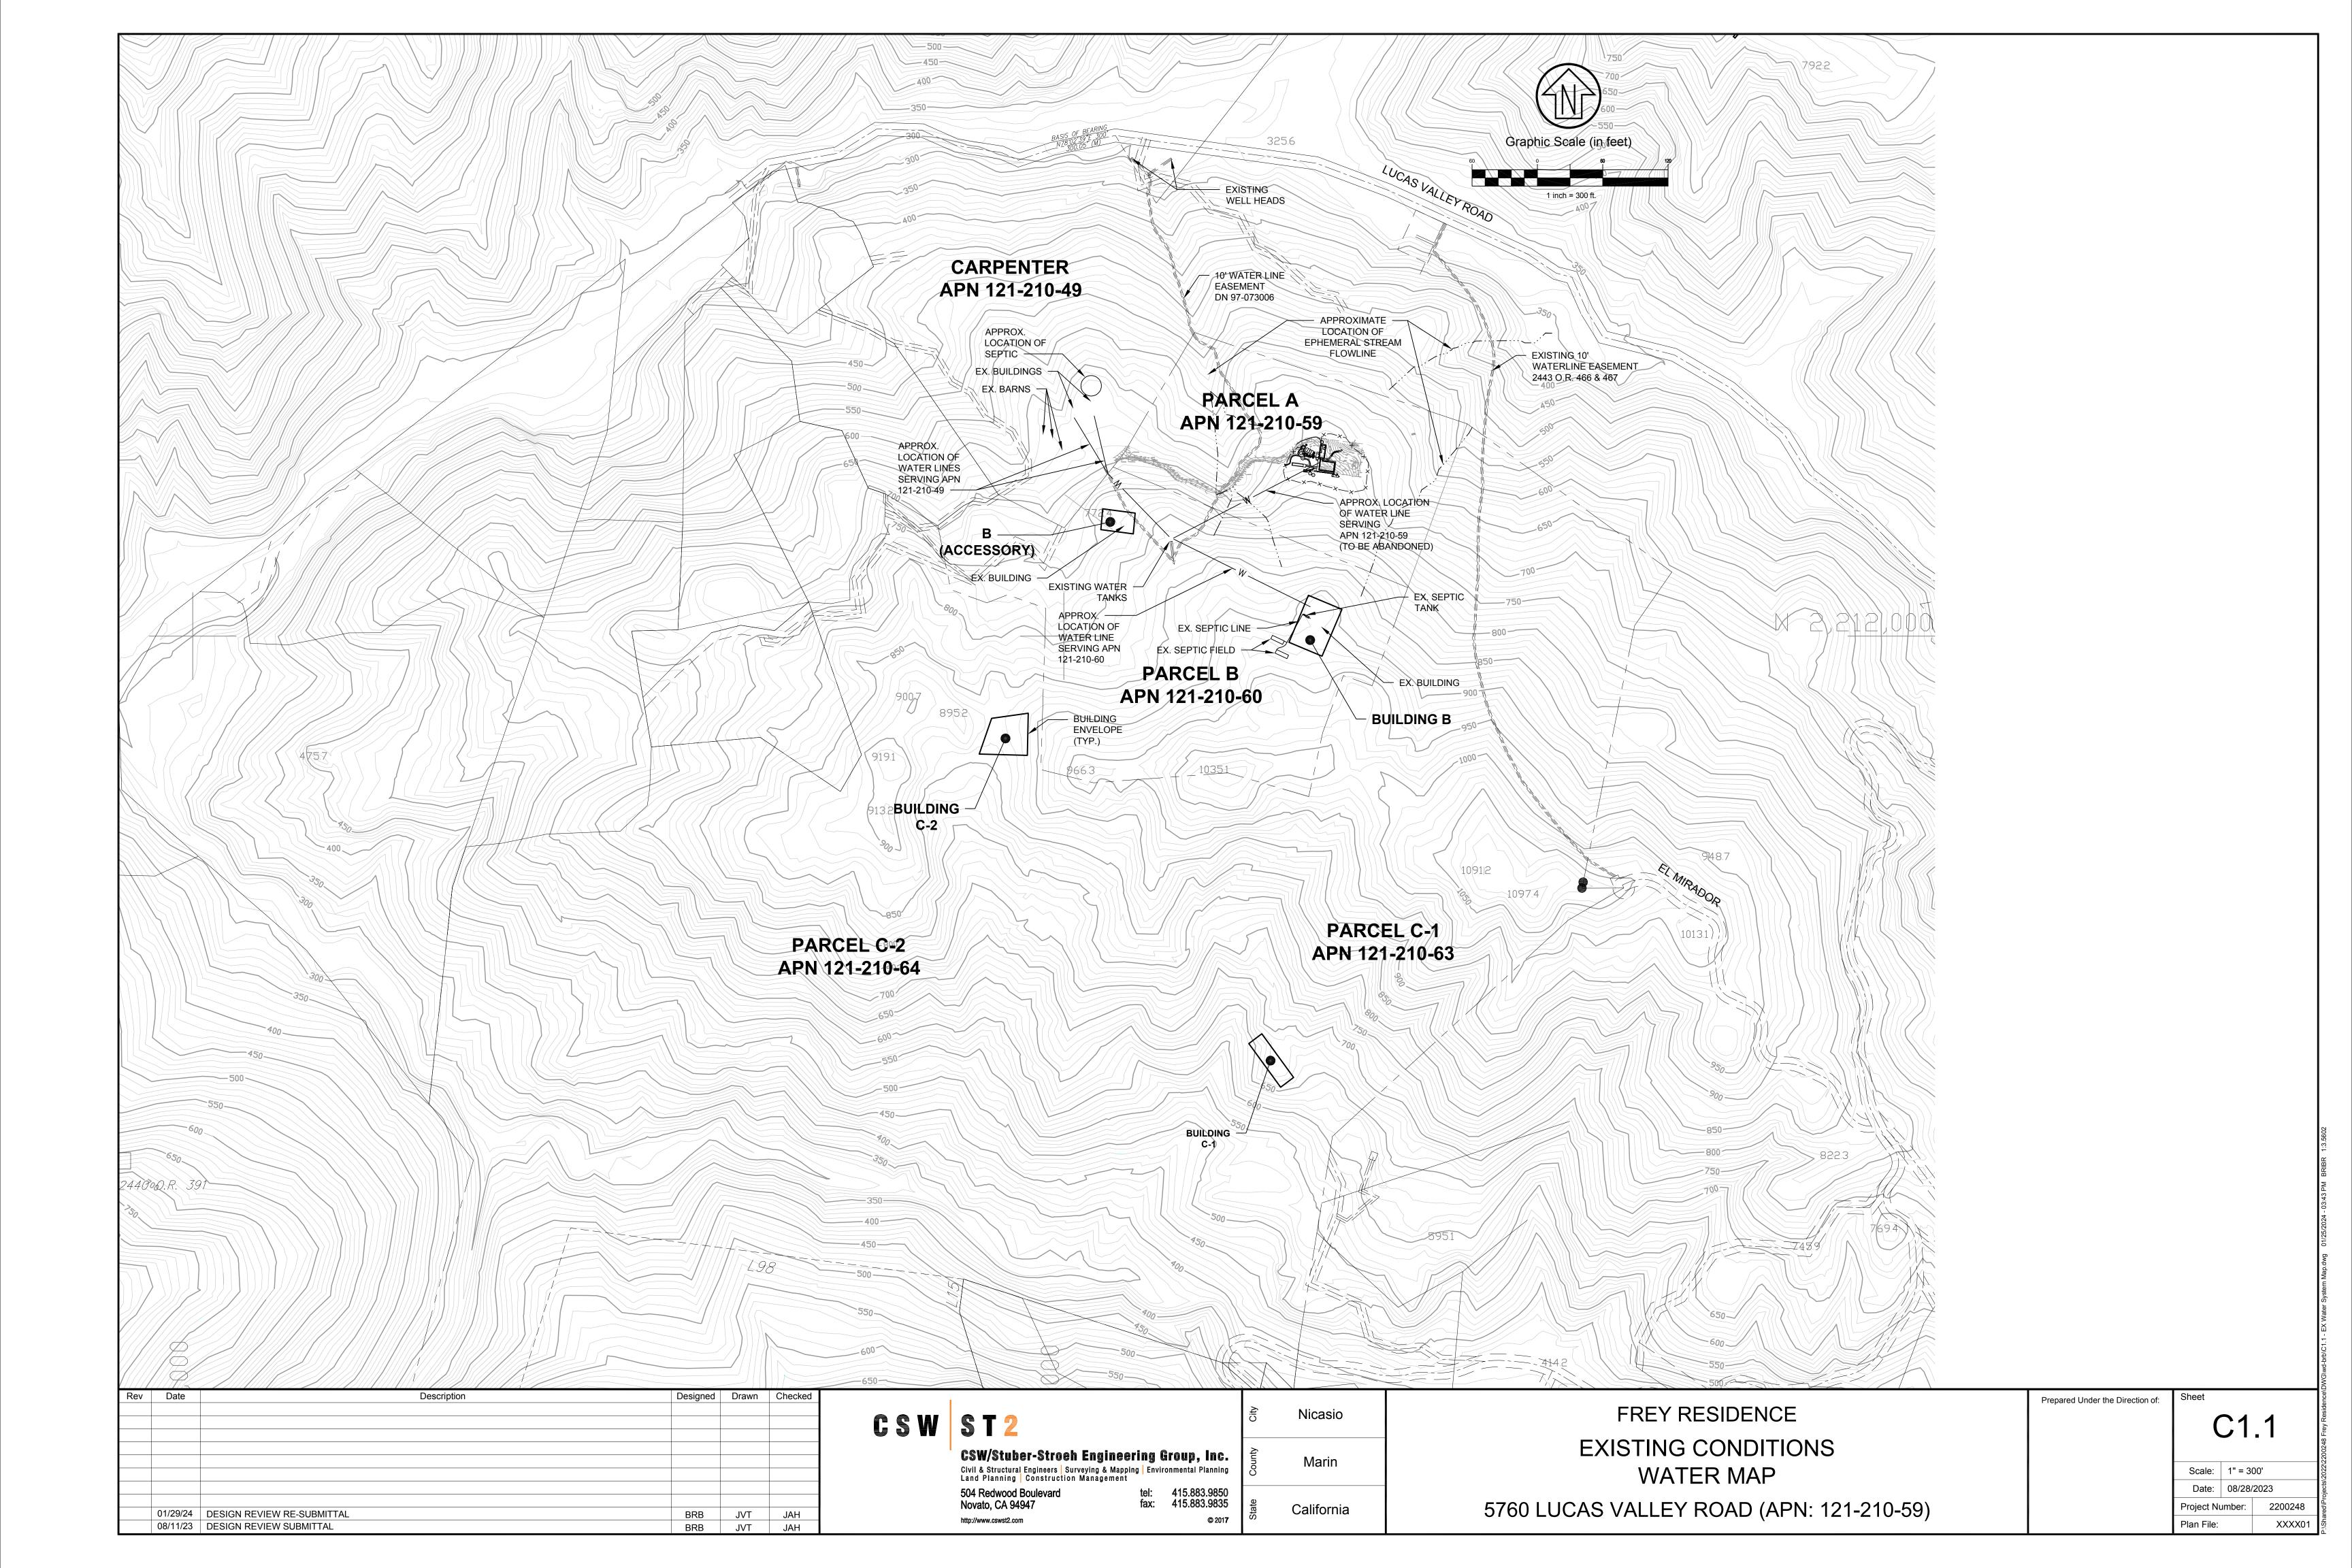

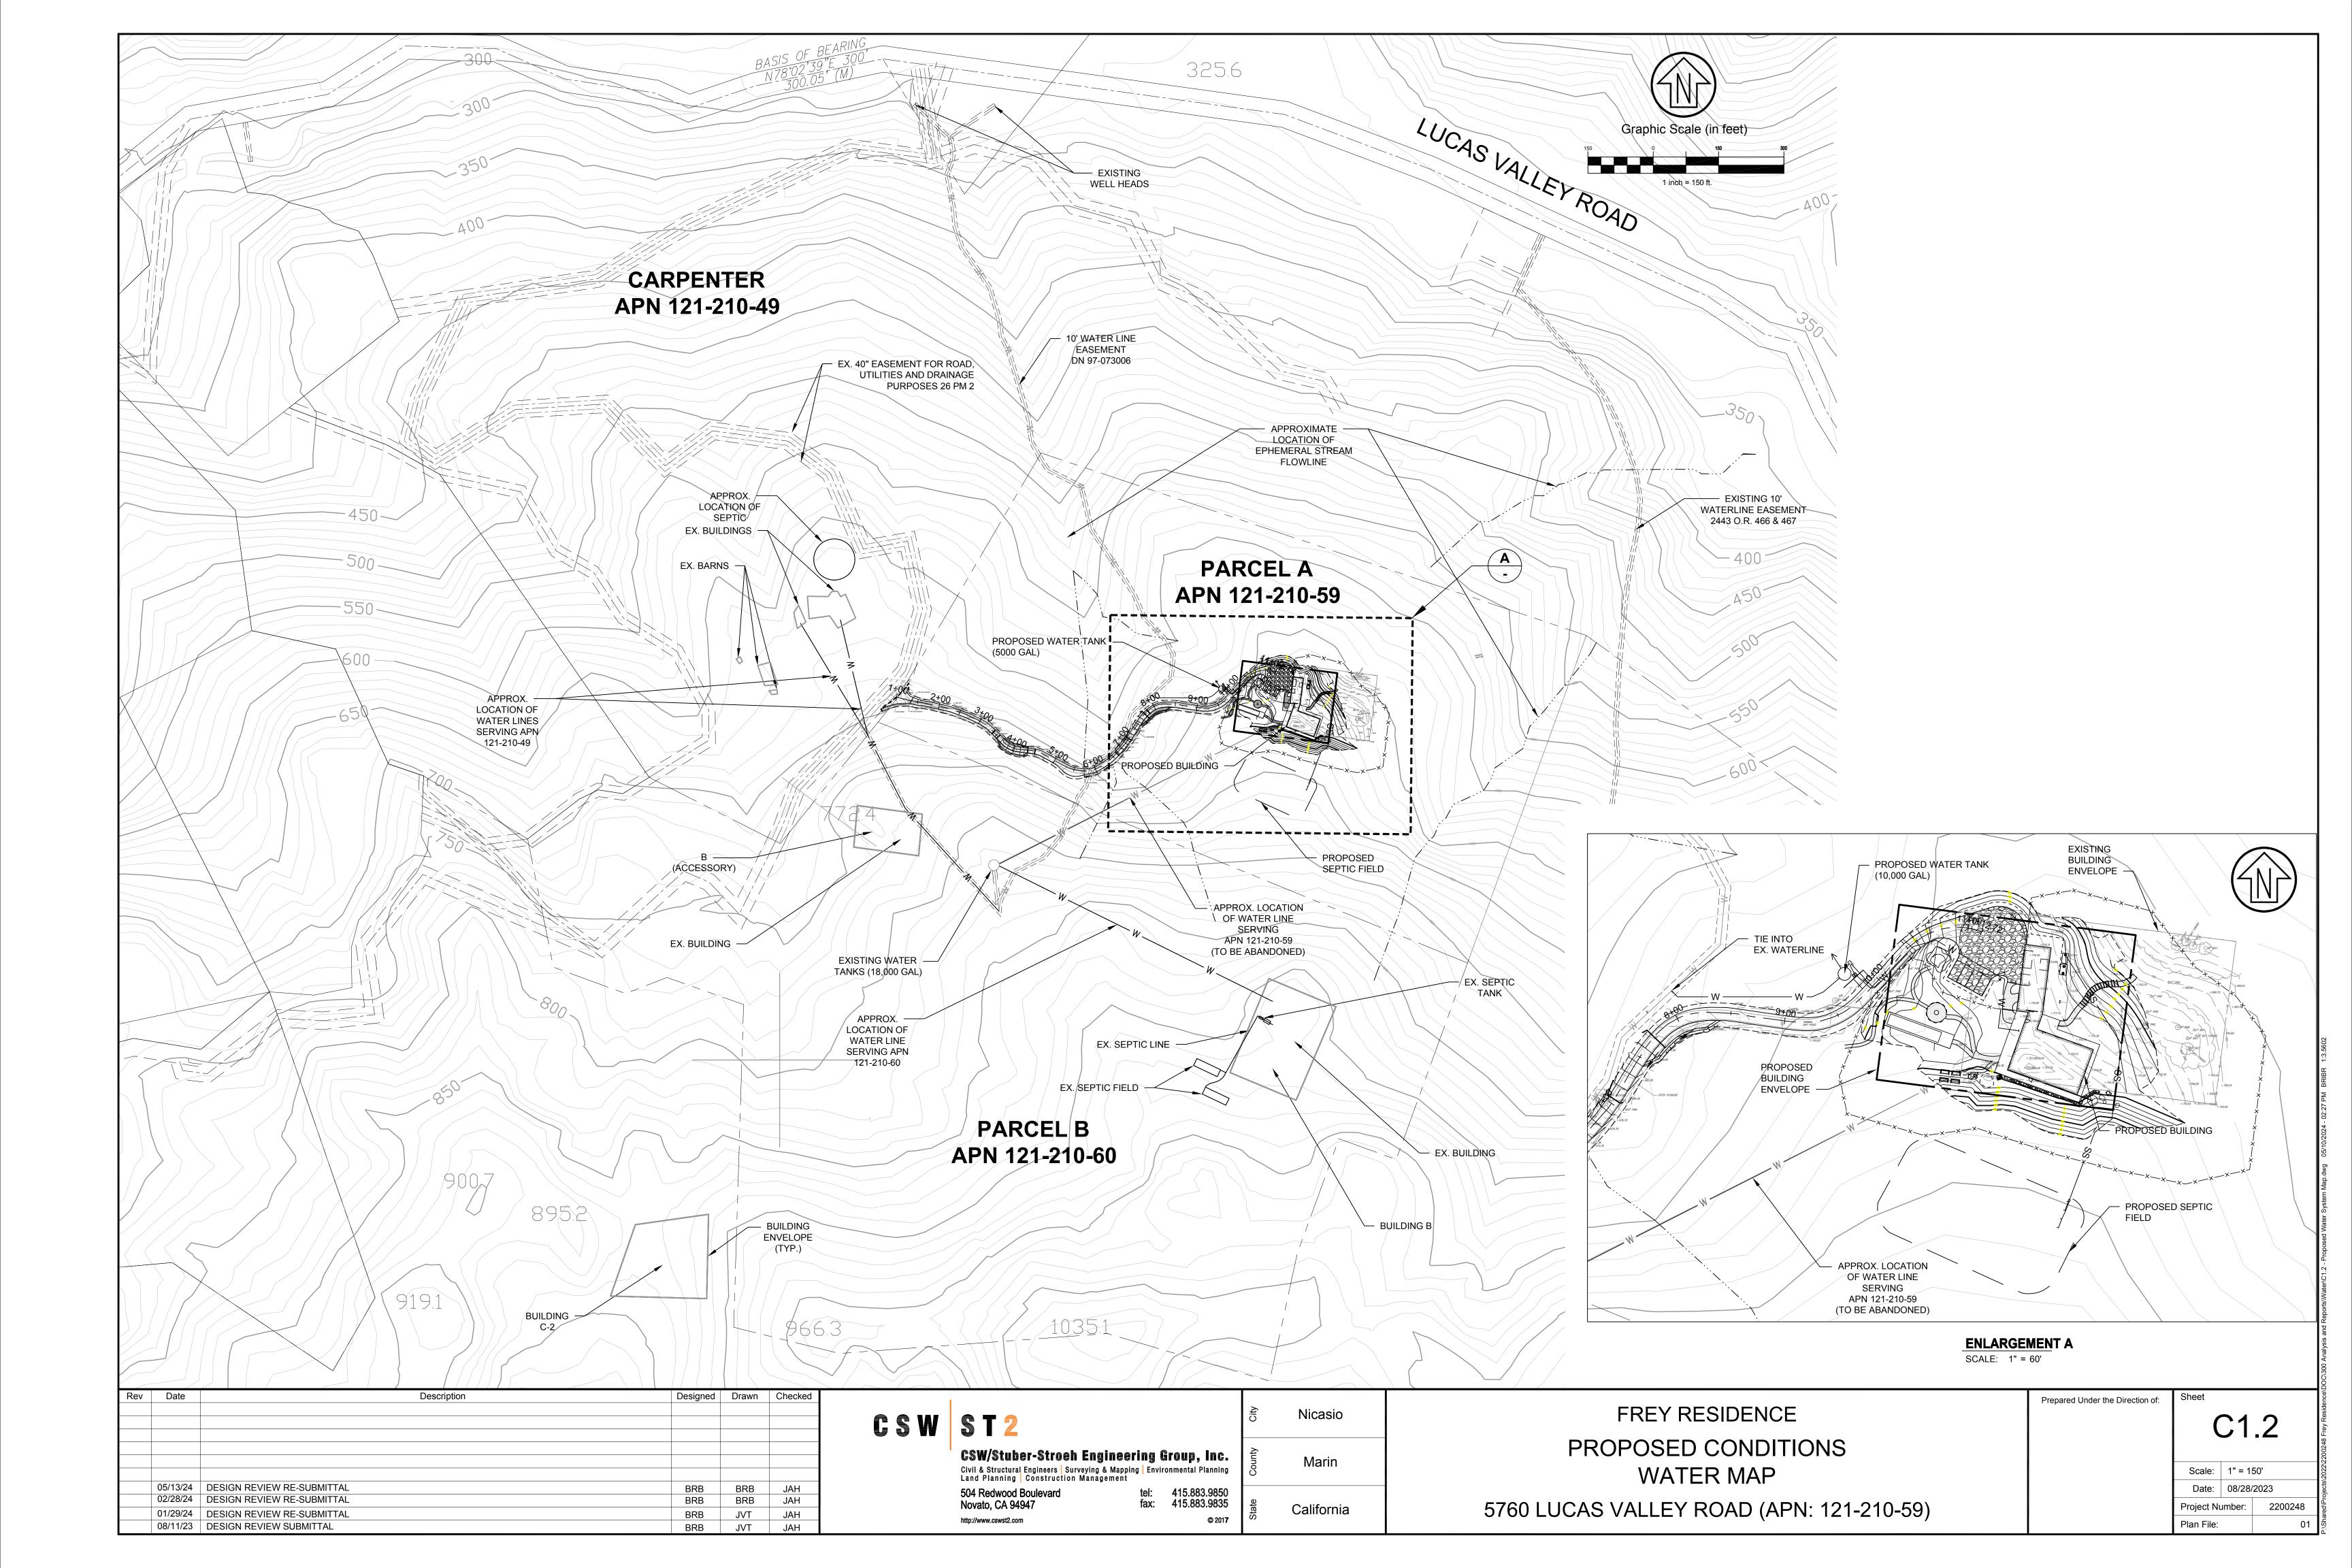

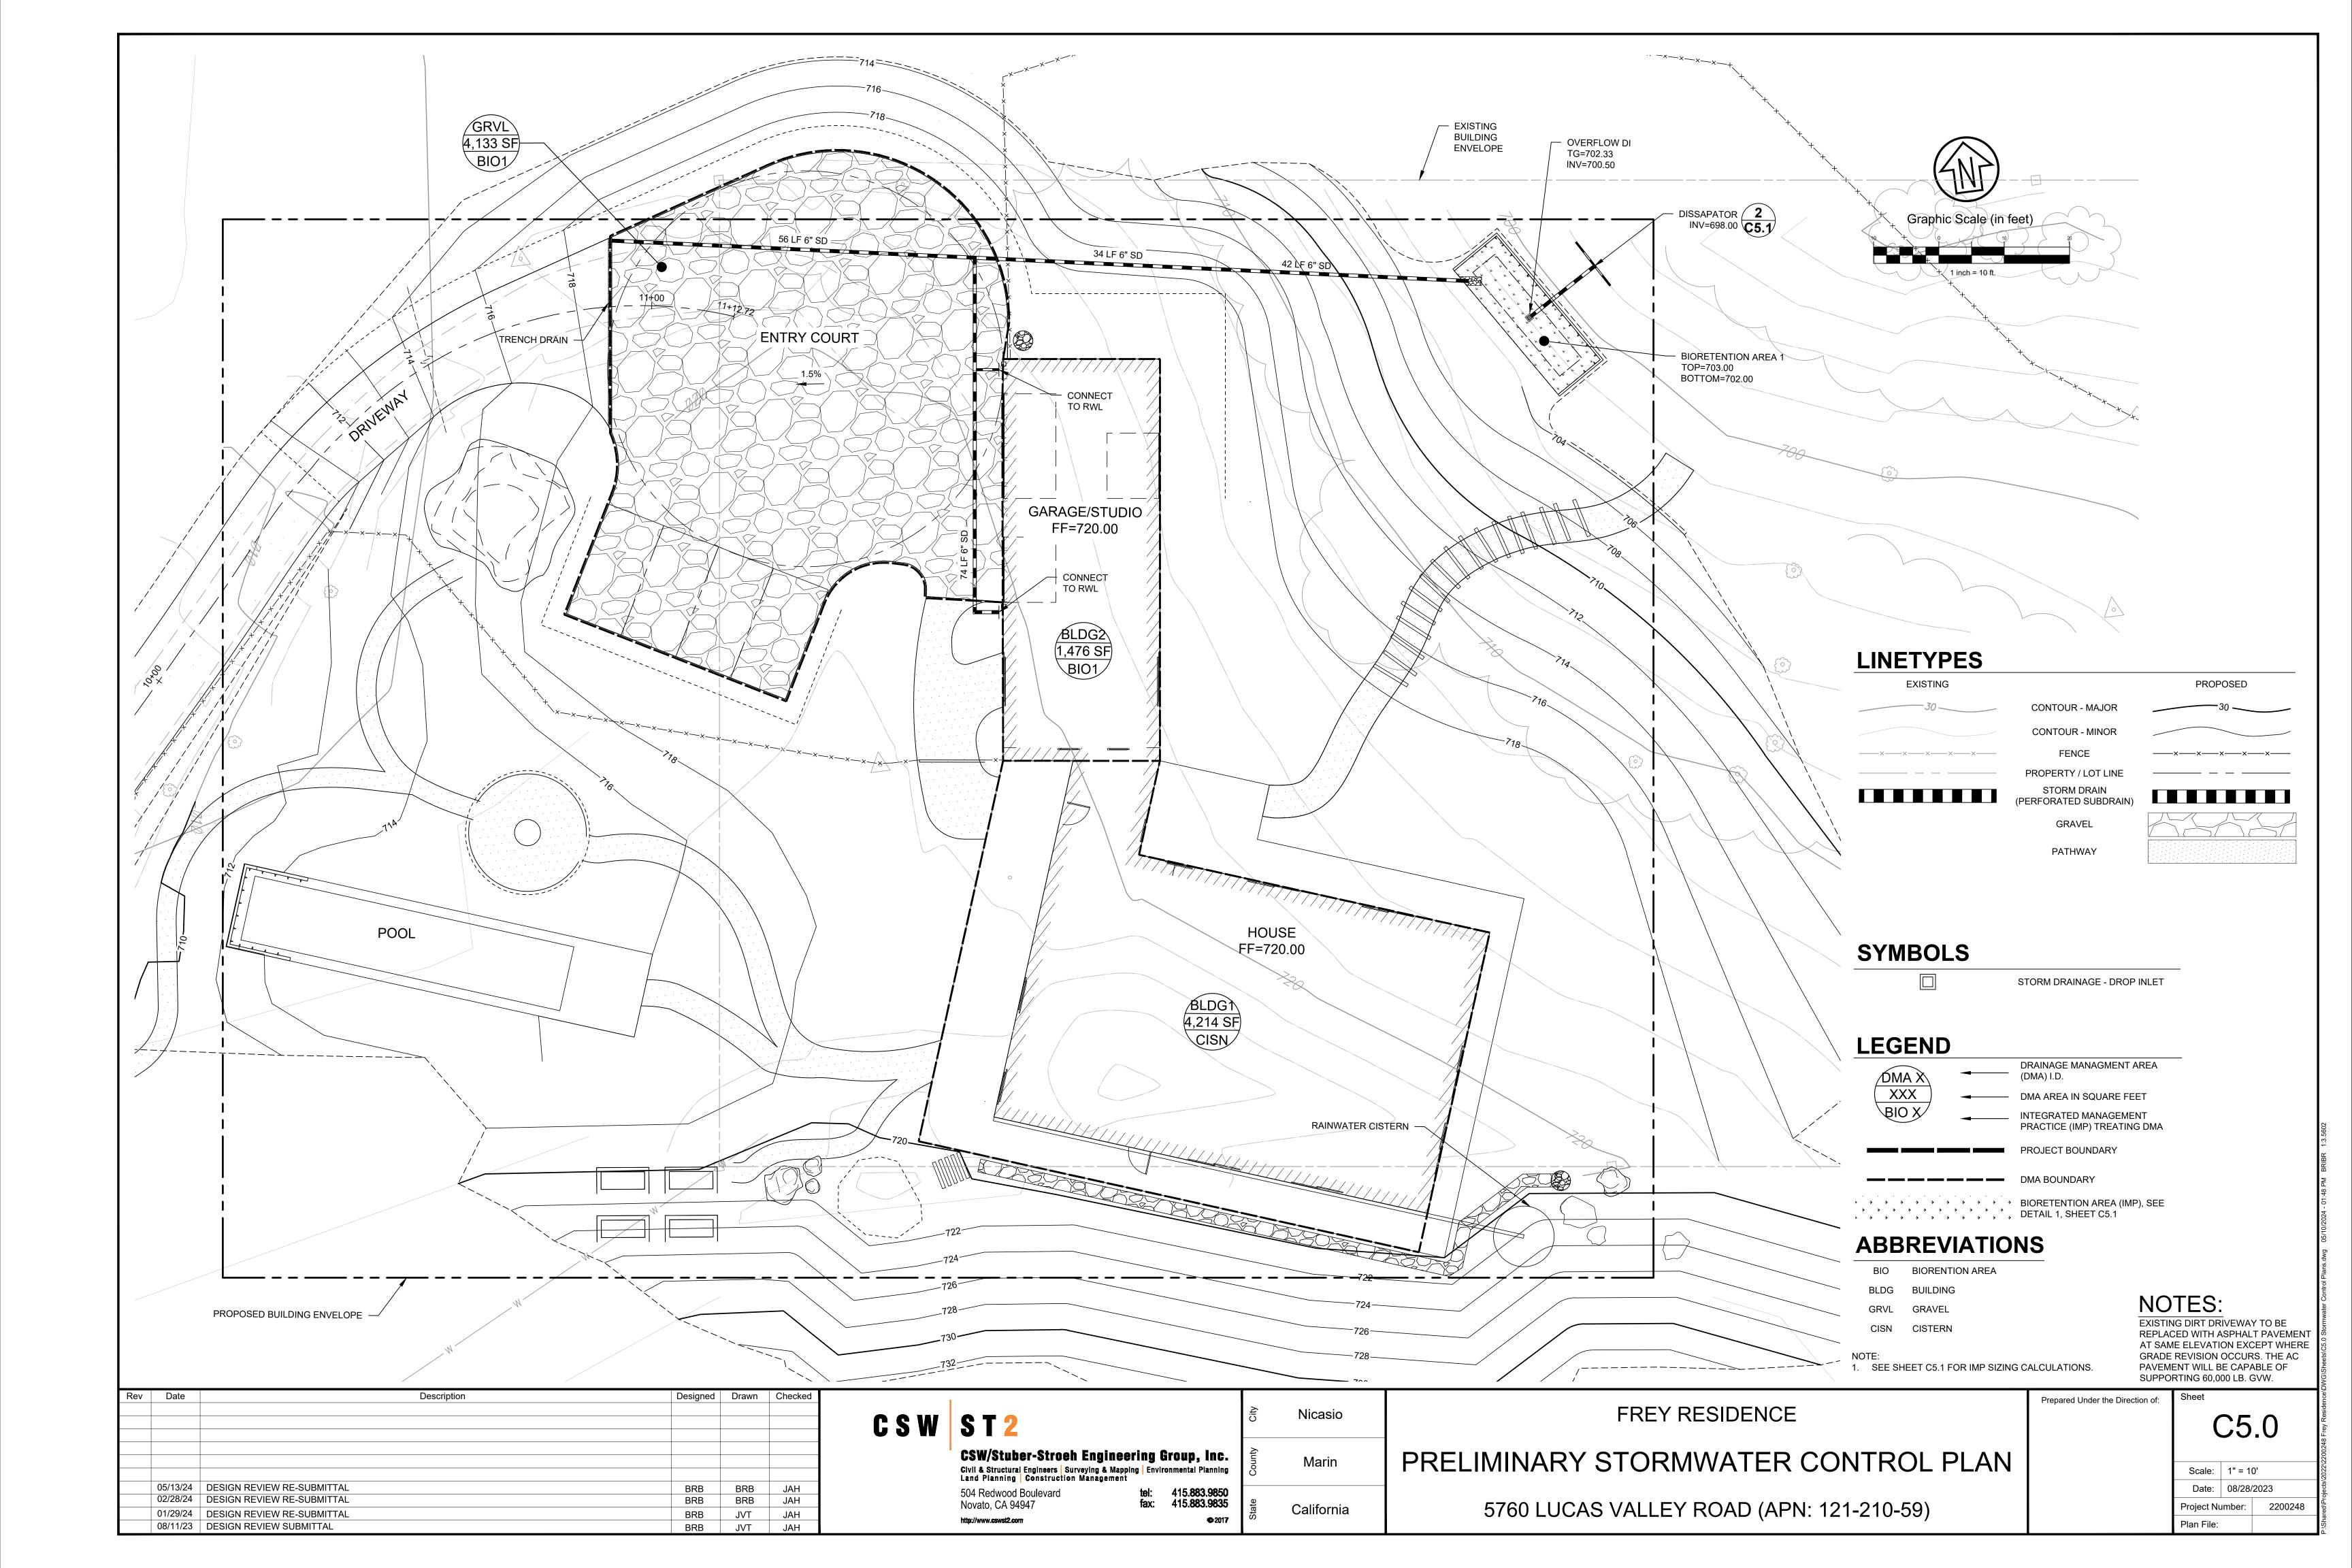

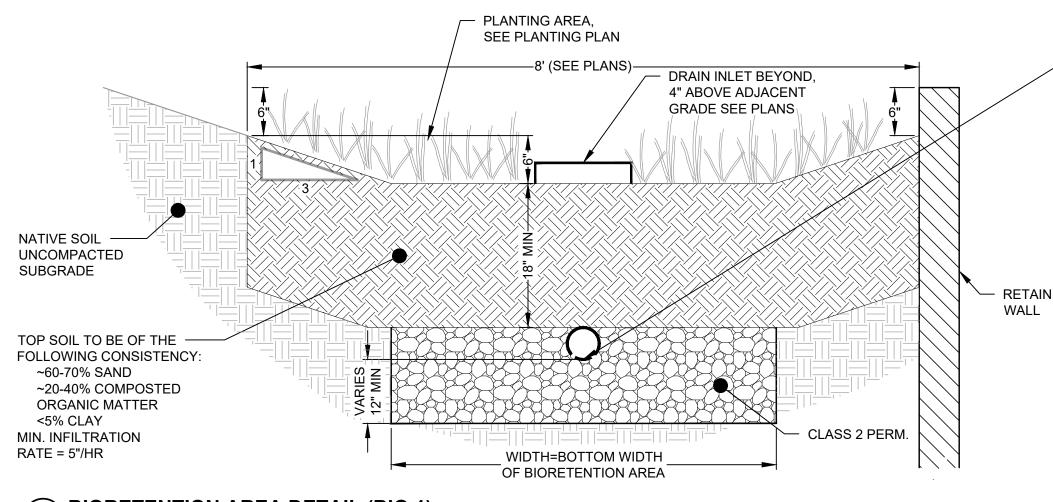

4" PERFORATED SDR 35 PIPE, HOLES FACE DOWN, 0.5% MIN, CONNECT TO STORM DRAIN INLET OR OUTFALL (PROVIDE CLEANOUTS AT ANGLE POINT AND ENDS)

BIORETENTION AREA CONSTRUCTION NOTES


- 1. SCARIFY SUBGRADE BEFORE INSTALLING BIORETENTION AREA AGGREGATE AND BIORETNETION
- 2. INSTALL UNDERDRAIN WITH HOLES FACING DOWN. UNDERDRAIN DISCHARGE ELEVATION SHALL BE NEAR TOP OF AGGREGATE LAYER. UNDERDRAIN SLOPE MAY COMPACT EACH 6" LIFT OF BIORETENTION SOIL MEDIA
- WETTING, LET DRY OVERNIGHT BEFORE PLANTING. NEVER WORK WITHIN BIORETENTION AREA LIMITS DURING RAIN OR UNDER WET CONDITIONS. 5. KEEP ALL HEAVY MACHINERY OUTSIDE BIORETENTION

WITH LANDSCAPE ROLLER OR BY LIGHTLY WETTING. IF

AREA LIMITS. CONTRACTOR SHALL PROVIDE SUBMITTALS CERTIFYING CLASS 2 PERM MEETS CALTRANS SPECIFICATION 68-2.02F(3) AND BIORETENTION SOIL

MEET REQUIREMENTS OF BASMAA

POST-CONSTRUCTION MANUAL. CONTRACTOR SHALL NOTIFY CIVIL ENGINEER 48 HOURS PRIOR TO INSTALLATION OF CLASS 2 PERM AND BIORETENTION SOIL FOR INSPECTION.

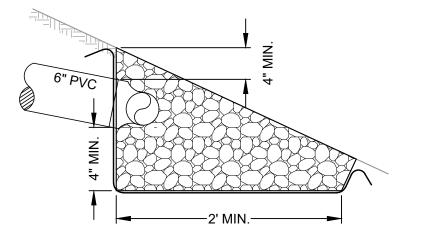

DRAIN DISSIPATER DETAIL

SCALE: 1" = 1'

7,142 SF DISCHARGE TO RAINWATER

DISCHARGE TO SELF-TREATING

DISCHARGE TO SELF-TREATING 6,094 SF

CISTERN 4,214 SF

	•						
	DMA		DMA	DMA AREA X	IMP NAME		
DMA NAME	AREA (SF)	POST- PROJECT SURFACE TYPE	RUNOFF FACTOR	RUNOFF FACTOR		BIO1	
BLDG2	1,476	ROOF	1.0	1,476	IMP	MIN. SIZING	PRO. SIZING
GRVL	4,133	GRAVEL	0.1	413	SIZING FACTOR	FACTOR (SF)	FACTOR (SF)
TOTAL >				1,889	0.04	76	90

1 BIORETENTION AREA DETAIL (BIO 1)

Step 1: Project Data Form and Runoff Reduction Measure Selection

Complete all fields

Project Name/Number	Frey Residence
Application Submittal Date [to be verified by municipal staff]	
Project Location [Street Address if available, or intersection and/or APN]	2760 Lucas Valley Road, Nicasio Parcel "A" Lucas Valley Road APN: 121-210-59
Name of Owner or Developer	Jochen & Tina Frey
Project Type and Description	Single Family Home
Total Project Site Area (acres)	24.006
Total New or Replaced Impervious Surface Area (square feet) [Sum of impervious area that will be constructed as part of the project]	19,482 sf (6,246 sf Residence: 13,236 sf Driveway)
Total Pre-Project Impervious Surface Area (square feet)	0
Total Post-Project Impervious Surface Area (square feet)	19,482 sf
Runoff Reduction Measures Selected (Check one or more)	 1. Disperse runoff to vegetated area 2. Pervious pavement 3. Cisterns or Rain Barrels 4. Bioretention Facility or Planter Box

Step 2: Delineate impervious areas and locations of runoff reduction measures

Delineate the impervious area. On a site plan or sketch, show the impervious area—for example, a roof, or portion of a roof, or a paved area—that will drain to your runoff reduction measure. Typically these delineations follow roof ridge lines or grade breaks. Alternatively, show the type and extent of pervious paving. An example sketch is attached.

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Option 3: Cisterns or Rain Barrels

Use of cisterns or rain barrels to comply with this requirement is subject to municipality approval. Planning and Building Permits may be required for larger systems.

NOTE: PROVIDE THREADED PLUG AT EACH END TO ALLOW FLUSHING OF DEBRIS.

Show on your site plan:

- Impervious areas tributary to each cistern or rain barrel.
- Location of each cistern or rain barrel.

Confirm the following standard specifications are met:

- Rain barrels are sited at grade on a sound and level surface at or near gutter downspouts.
- ☐ Gutters tributary to rain barrels are screened with a leaf guard or maximum ½-inch to ¼-inchminimum corrosion-resistant metallic hardware fabric.
- Water collected will be used for irrigation only.
- Denings are screened with a corrosion-resistant metallic fine mesh (1/16 inch or smaller) to prevent
- Large openings are secured to prevent entry by children.
- A Rain barrels and gutters are to be cleaned annually.
- The local mosquito and vector control district is informed of the installation. The district will be provided additional information and/or rights of entry if they request.

Page 5 of 8

Option 4: Bioretention Facility or Planter Box

An above-ground planter box may be appropriate if the development site lacks level landscaped areas for dispersion and pervious pavements are not practical. Planter boxes and bioretention facilities can treat runoff from impervious surfaces 25 times their area (sizing factor of 0.04).

Detailed design guidance for bioretention facilities is in the Stormwater Technical Guide.

Show on your site plan:

- ☑ Impervious areas tributary to the planter box.
- Location and footprint of planter box.

Confirm the following standard specifications are met:

- Reservoir depth is 4"-6" minimum.
- 18" depth soil mix with minimum long-term infiltration rate of 5"/hour. See http://www.cccleanwater.org/c3-guidebook.html for a list of soil mix suppliers.
- Surface area of soil mix is a minimum 0.04 times the tributary impervious area.
- "Class 2 perm" drainage layer 12" deep.
- No filter fabric.
- Perforated pipe (PVC SDR 35 or approved equivalent) underdrain with outlet located flush or nearly flush with planter bottom.
- Connection with sufficient head to storm drain or discharge point.
- Underdrain has a clean-out port consisting of a vertical, rigid, non-perforated PVC pipe, connected to the underdrain via a sweep bend, with a minimum diameter of 4" and a watertight cap.
- Overflow outlet connected to a downstream storm drain or approved discharge point.
- Planter is set level.
- Emergency spillage will be safely conveyed overland.
- Plantings are suitable to the climate, exposure, and a well-drained soil.
- Irrigation system with connection to water supply, on a separate zone.

30 JUNE 2023

Page 6 of 8

Flow-through planter built into a hillside.

Flows from the underdrain and overflow

must be directed in accordance with local

Rev	Date	Description	Designed	Drawn	Checked
	05/13/24	DESIGN REVIEW RE-SUBMITTAL	BRB	BRB	JAH
	02/28/24	DESIGN REVIEW RE-SUBMITTAL	BRB	BRB	JAH
	01/29/24	DESIGN REVIEW RE-SUBMITTAL	BRB	JVT	JAH
	08/11/23	DESIGN REVIEW SUBMITTAL	BRB	JVT	JAH

2.829M [9'-3 1/2"] ——

3500 GALLON CAPACITY RAINWATER CISTERN
SCALE: NTS

ELEVATION

CSW ST2

504 Redwood Boulevard Novato, CA 94947

http://www.cswst2.com

BASMAA

CSW/Stuber-Stroeh Engineering Group, Inc. Civil & Structural Engineers | Surveying & Mapping | Environmental Planning Land Planning | Construction Management

415.**883**.9850 415.**883**.9835

Nicasio Marin California

30 JUNE 2023

FREY RESIDENCE STORMWATER CONTROL NOTES & DETAILS


5760 LUCAS VALLEY ROAD (APN: 121-210-59)

BASMAA

Prepared Under the Direction of:

C5.1 Scale: 1" = 10'

Date: 08/28/2023 2200248 Project Number: Plan File:

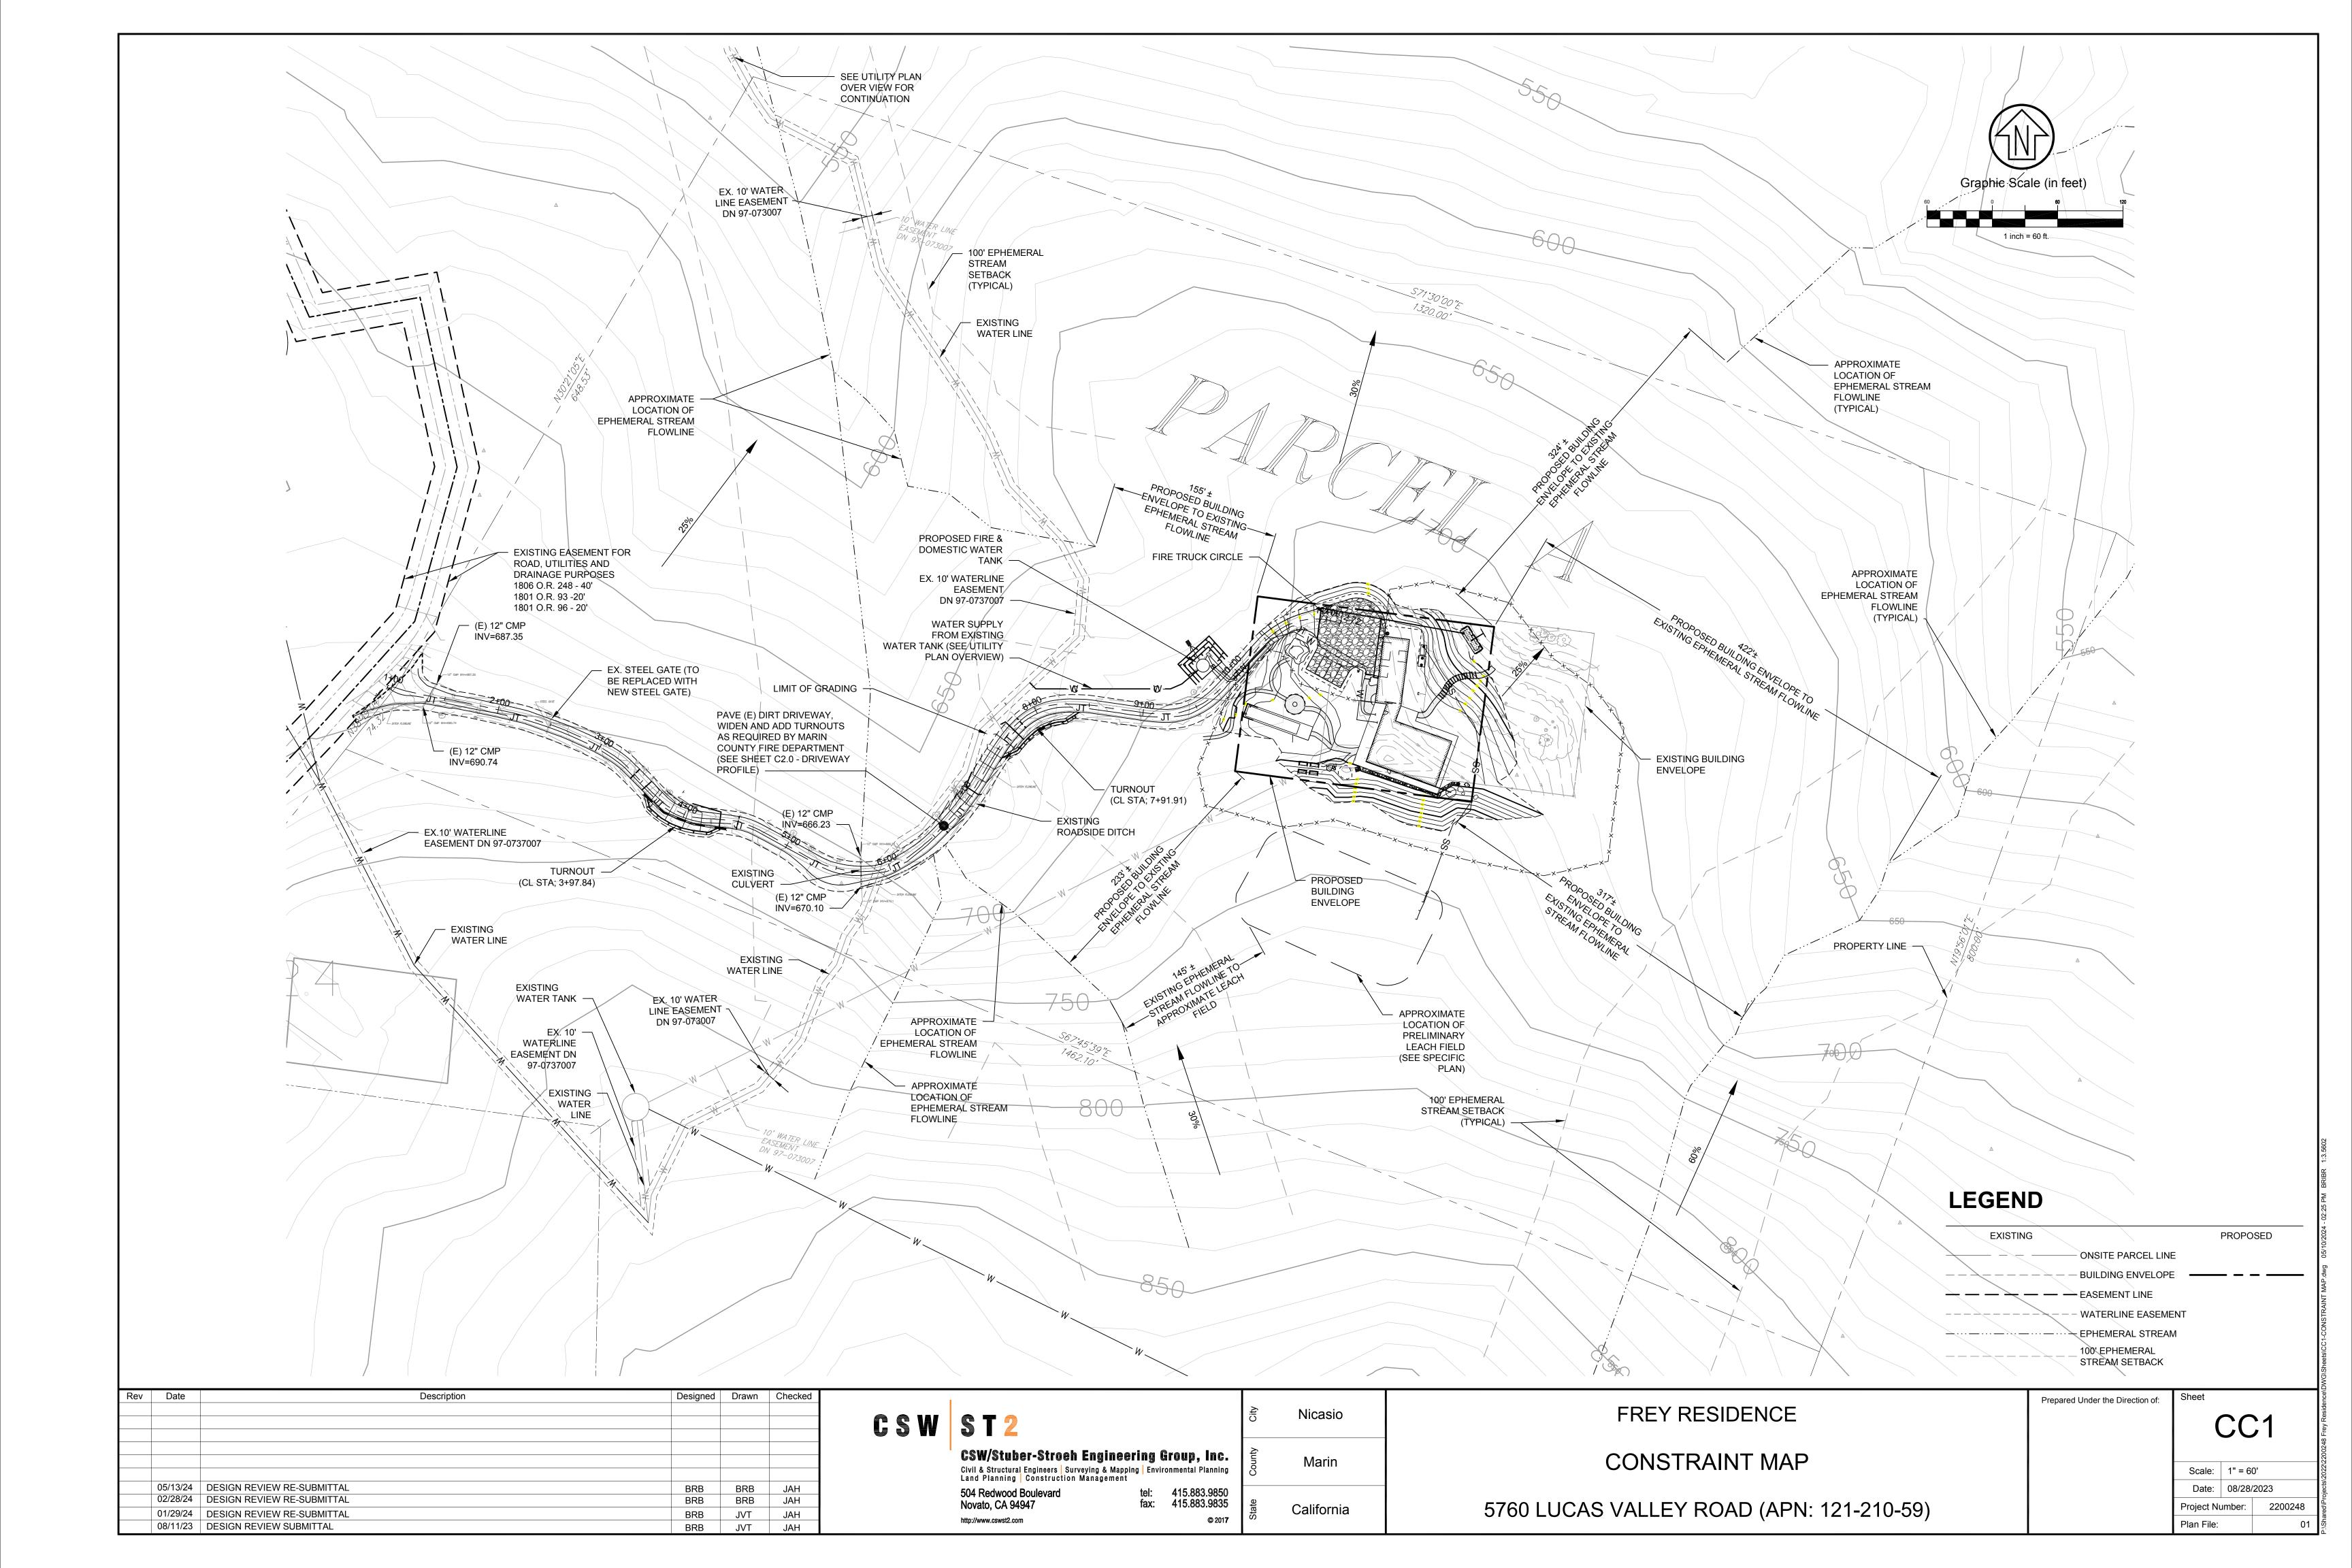

PRELIMINARY PROJECT SCHEDULE


	PRELIMINARY PROJECT SCHEDULE																		
				20)23			2024											
ID	TASK NAME	JULY	AUG.	SEPT.	ост.	NOV.	DEC.	JAN.	FEB.	MAR.	APR.	MAY	JUNE	JULY	AUG.	SEPT.	ОСТ.	NOV.	DEC.
1	MOBILIZATION/EROSION CONTROL	→ → →	-																
2	SITE CLEARING/GRADING																		
3	DRAINAGE/UTILITIES																		
4	FOUNDATION				→ → → →	→ → →													
5	ROUGH FRAME																		
6	INTERIOR FINISH																		
7	COMPLETION/PUNCH LIST																	→ → → →	→→→→

CONSTRUCTION TRAFFIC / VEHICLE ROUTE / DUST CONTROL

- 7AM TO 6MP MONDAY THROUGH FRIDAY AND 9AM TO 5PM ON SATURDAYS. LARGE NOISE GENERATING EQUIPMENT CAN OPERATE ONLY BETWEEN 8AM AND 5PM ON MONDAY THROUGH FRIDAY. CONSTRUCTION WORK IS NOT ALLOWED ON SUNDAYS AND HOLIDAYS.
- FROM HIGHWAY 101 NORTH OR SOUTHBOUND TAKE THE LUCAS VALLEY ROAD/SMITH RANCH ROAD EXIT TOWARDS LUCAS VALLEY. PROCEED WEST ON LUCAS VALLEY ROAD THROUGH THE "HUB" (LUCAS VALLEY). APPROXIMATELY 6 MILES BEYOND THE "HUB" TURN LEFT (NORTHWEST) ONTO THE FIRE ROAD. PROCEED OVER THE BRIDGE ACROSS NICASIO CREEK AND TURN RIGHT CONTINUING ON THE FIRE ROAD. CONTINUE ON THE FIRE ROAD UNTIL ARRIVING AT THE PROJECT SITE DRIVEWAY ON THE LEFT.

*PARK ALL CARS AND TRUCKS AS INDICATED ON THE CONSTRUCTION MANAGEMENT SITE PLAN (SEE RIGHT). CARS AND TRUCKS SHALL TURN AROUND AT THE PROJECT SITE AND RETURN ON THE DESIGNATED TRUCK ROUTE THE SAME WAY THEY ARRIVED.

- DELIVERIES ARE LIMITED TO WEEKDAYS FROM 9AM TO 3PM. FOR TRUCKS EXCEEDING 20 FEET IN LENGTH, NOTICE MUST BE GIVEN TO NEIGHBORING RESIDENTS A MINIMUM OF 24 HOURS IN ADVANCE LOCAL TRAFFIC CONTROL, INCLUDING FLAGGERS, SHALL BE ADDED AS REQUIRED FOR LARGER TRUCKS.
- PERMITS MUST BE OBTAINED FROM THE MARIN COUNTY DEPARTMENT OF PUBLIC WORKS. ROAD CLOSURES REQUIRE POSTING SIGNS A MINIMUM OF 48 HOURS IN ADVANCE. COPIES OF THESE PERMITS MUST BE MAINTAINED AT THE JOB SITE FOR THE DURATION OF THE CLOSURE. ALL ROAD CLOSURES REQUIRE TRAFFIC CONTROL INCLUDING FLAGGERS WHEN WARRANTED.
- UP TO 8 WORKERS ARE ESTIMATED TO BE AT THE SITE AT ANY GIVEN TIME. THERE ARE 8 DESIGNATED PARKING SPACES ON-SITE UNTIL THE PARKING COURT AND PARKING STALLS ARE CREATED AT WHICH TIME THERE WILL BE AN ADDITIONAL 4 PARKING SPACES. ALL WORKERS ARE ENCOURAGED TO CARPOOL. WORKER VEHICLES MUST PARK AT JOB SITE OR CARPOOL. GENERAL CONTRACTOR TO DESIGNATE CARPOOL PICK-UP AND DROP-OFF LOCATIONS AND MUST NOT INTERFERE WITH PRIVATE PARKING AREAS.
- 1ST OFFENSE VIOLATION OF ANY PORTION OF THE APPROVED CONSTRUCTION MANAGEMENT PLAN OR OTHER APPLICABLE CONSTRUCTION MANAGEMENT REQUIREMENTS WILL BE ADDRESSED BY AN ORAL OR WRITTEN WARNING FROM THE COUNTY. ANY FURTHER OR SUBSEQUENT VIOLATIONS MAY BE ADDRESSED BY A "STOP WORK ORDER".
- 7. PROVIDE DUST REDUCTION CONSISTENT WITH THE BAY AREA AIR QUALITY MANAGEMENT DISTRICTS BASIC CONTROL MEASURES.

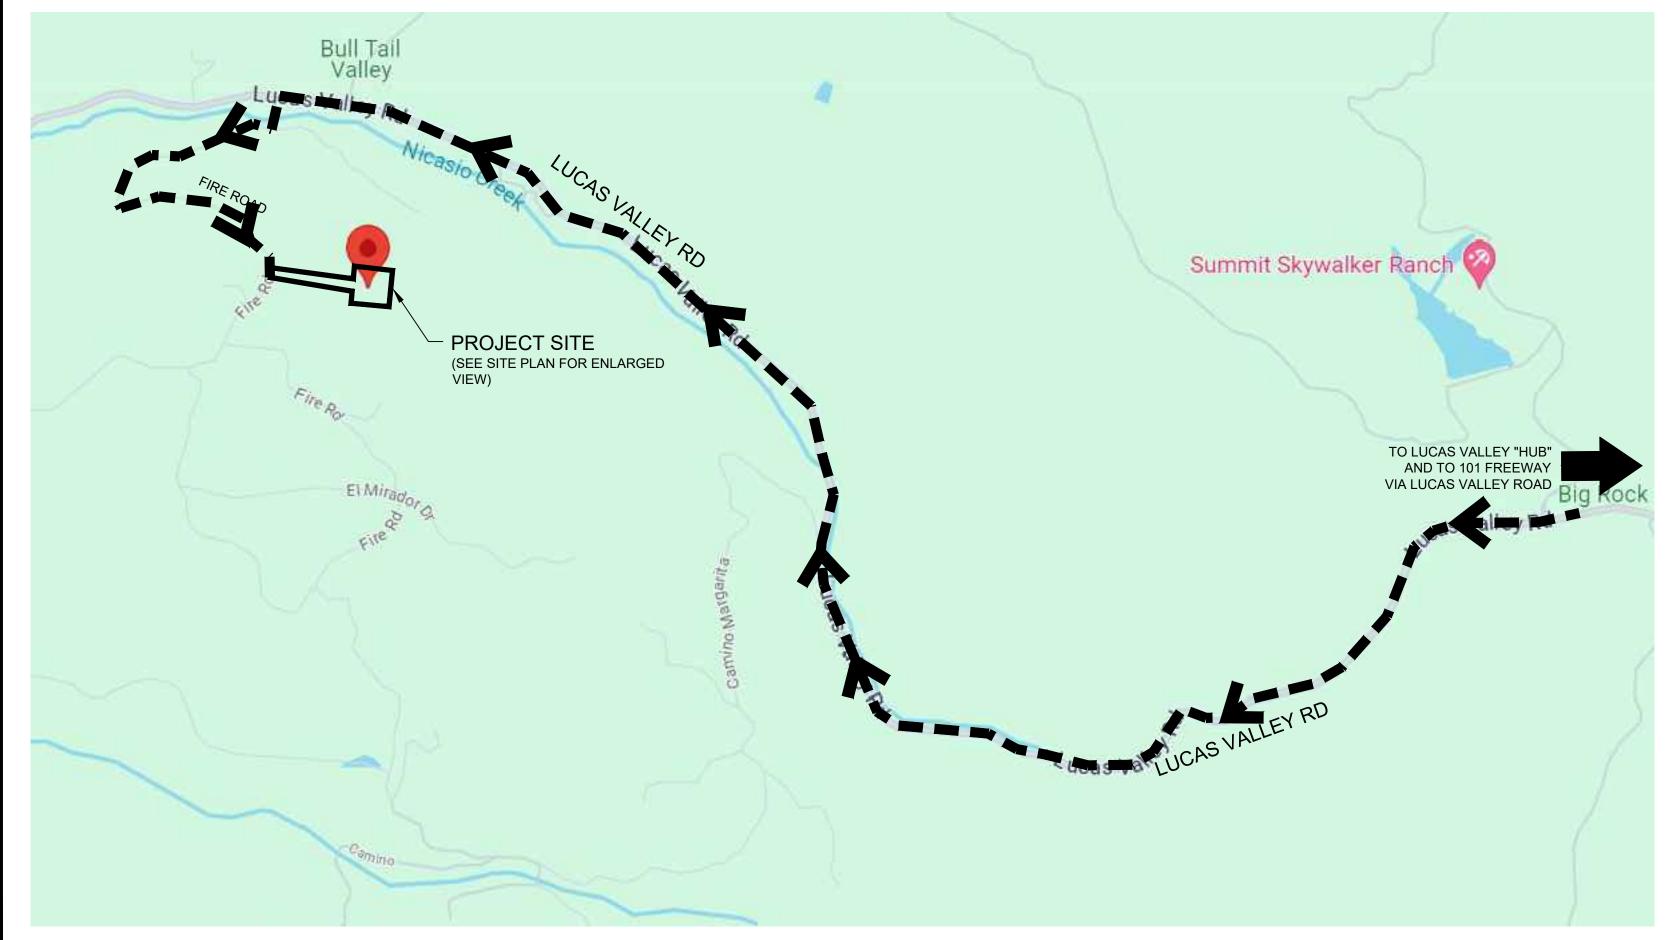

CONSTRUCTION VEHICLE ROUTE

NOT TO SCALE

Rev	Date	Description	Designed	Drawn	Checked
	05/13/24	DESIGN REVIEW RE-SUBMITTAL	BRB	BRB	JAH
	02/28/24	DESIGN REVIEW RE-SUBMITTAL	BRB	BRB	JAH
	01/29/24	DESIGN REVIEW RE-SUBMITTAL	BRB	JVT	JAH
	08/11/23	DESIGN REVIEW SUBMITTAL	BRB	I\/T	IAH

CSW ST2 CSW/Stuber-Stroeh Engineering Group, Inc. Civil & Structural Engineers | Surveying & Mapping | Environmental Planning Land Planning | Construction Management 415.**883**.9**850** 415.**883**.9**83**5 504 Redwood Boulevard Novato, CA 94947

Nicasio Marin California

PROPOSED BUILDING **ENVELOPE**

LIMITS OF GRADING & CONSTROCTUION

> FREY RESIDENCE CONSTRUCTION MANAGEMENT PLAN 5760 LUCAS VALLEY ROAD (APN: 121-210-59)

SCALE: 1" = 20'

SUBJECT PROPERTY

APN: 121-210-59

CONSTRUCTION MANAGEMENT SITE PLAN

PROVIDE & MAINTAIN MINIMUM 12' DRIVE AISLE FOR EMERENCY VEHICLES

PARCEL BOUNDARY

WORKER PARKING

MINIMUM 12' DRIVE AISLE

FOR EMERENCY VEHICLES AND RESIDENTS

(TYPICAL)

UNLOADING AREA

WORKER PARKING EXISTING DIRT DRIVEWAY TO BE REPLACED WITH ASPHALT PAVEMENT AT SAME ELEVATION EXCEPT/WHERE

CONSTRUCTION MANAGEMENT SITE PLAN - DRIVEWAY (START)

- (N) TURNOUT

- EXISTING DIRT DRIVEWAY TO BE REPLACED WITH ASPHALT PAVEMENT AT SAME ELEVATION EXCEPT WHERE

GRADE REVISION OCCURS.

CONSTRUCTION MANAGEMENT SITE PLAN - DRIVEWAY (END

NOTE: RELATIVELY FLAT NATURAL

AND EXISTING DRIVEWAY PAVING

GRADE AT THIS AREA TO BE UTILIZED AS CONSTRUCTION FACILITIES PRIOR

TO PARKING COURT CONSTRUCTION

GRADE REVISION OCCURS.

CONSTRUCTION

SUBJECT PROPERTY

APN: 121-210-59

SCALE: 1" = 40'

CONSTRUCTION

(N) TURNOUT

CONSTRUCTION

(N) GARAGE

(N) RESIDENCE

NOTE: SEE SEPARATE EROSION AND SEDIMENT CONTROL PLAN BY CIVIL ENGINEER

LIMIT OF

NEIGHBORING PARCEL

PARCEL C APN: 121-210-60


CONSTRUCTION


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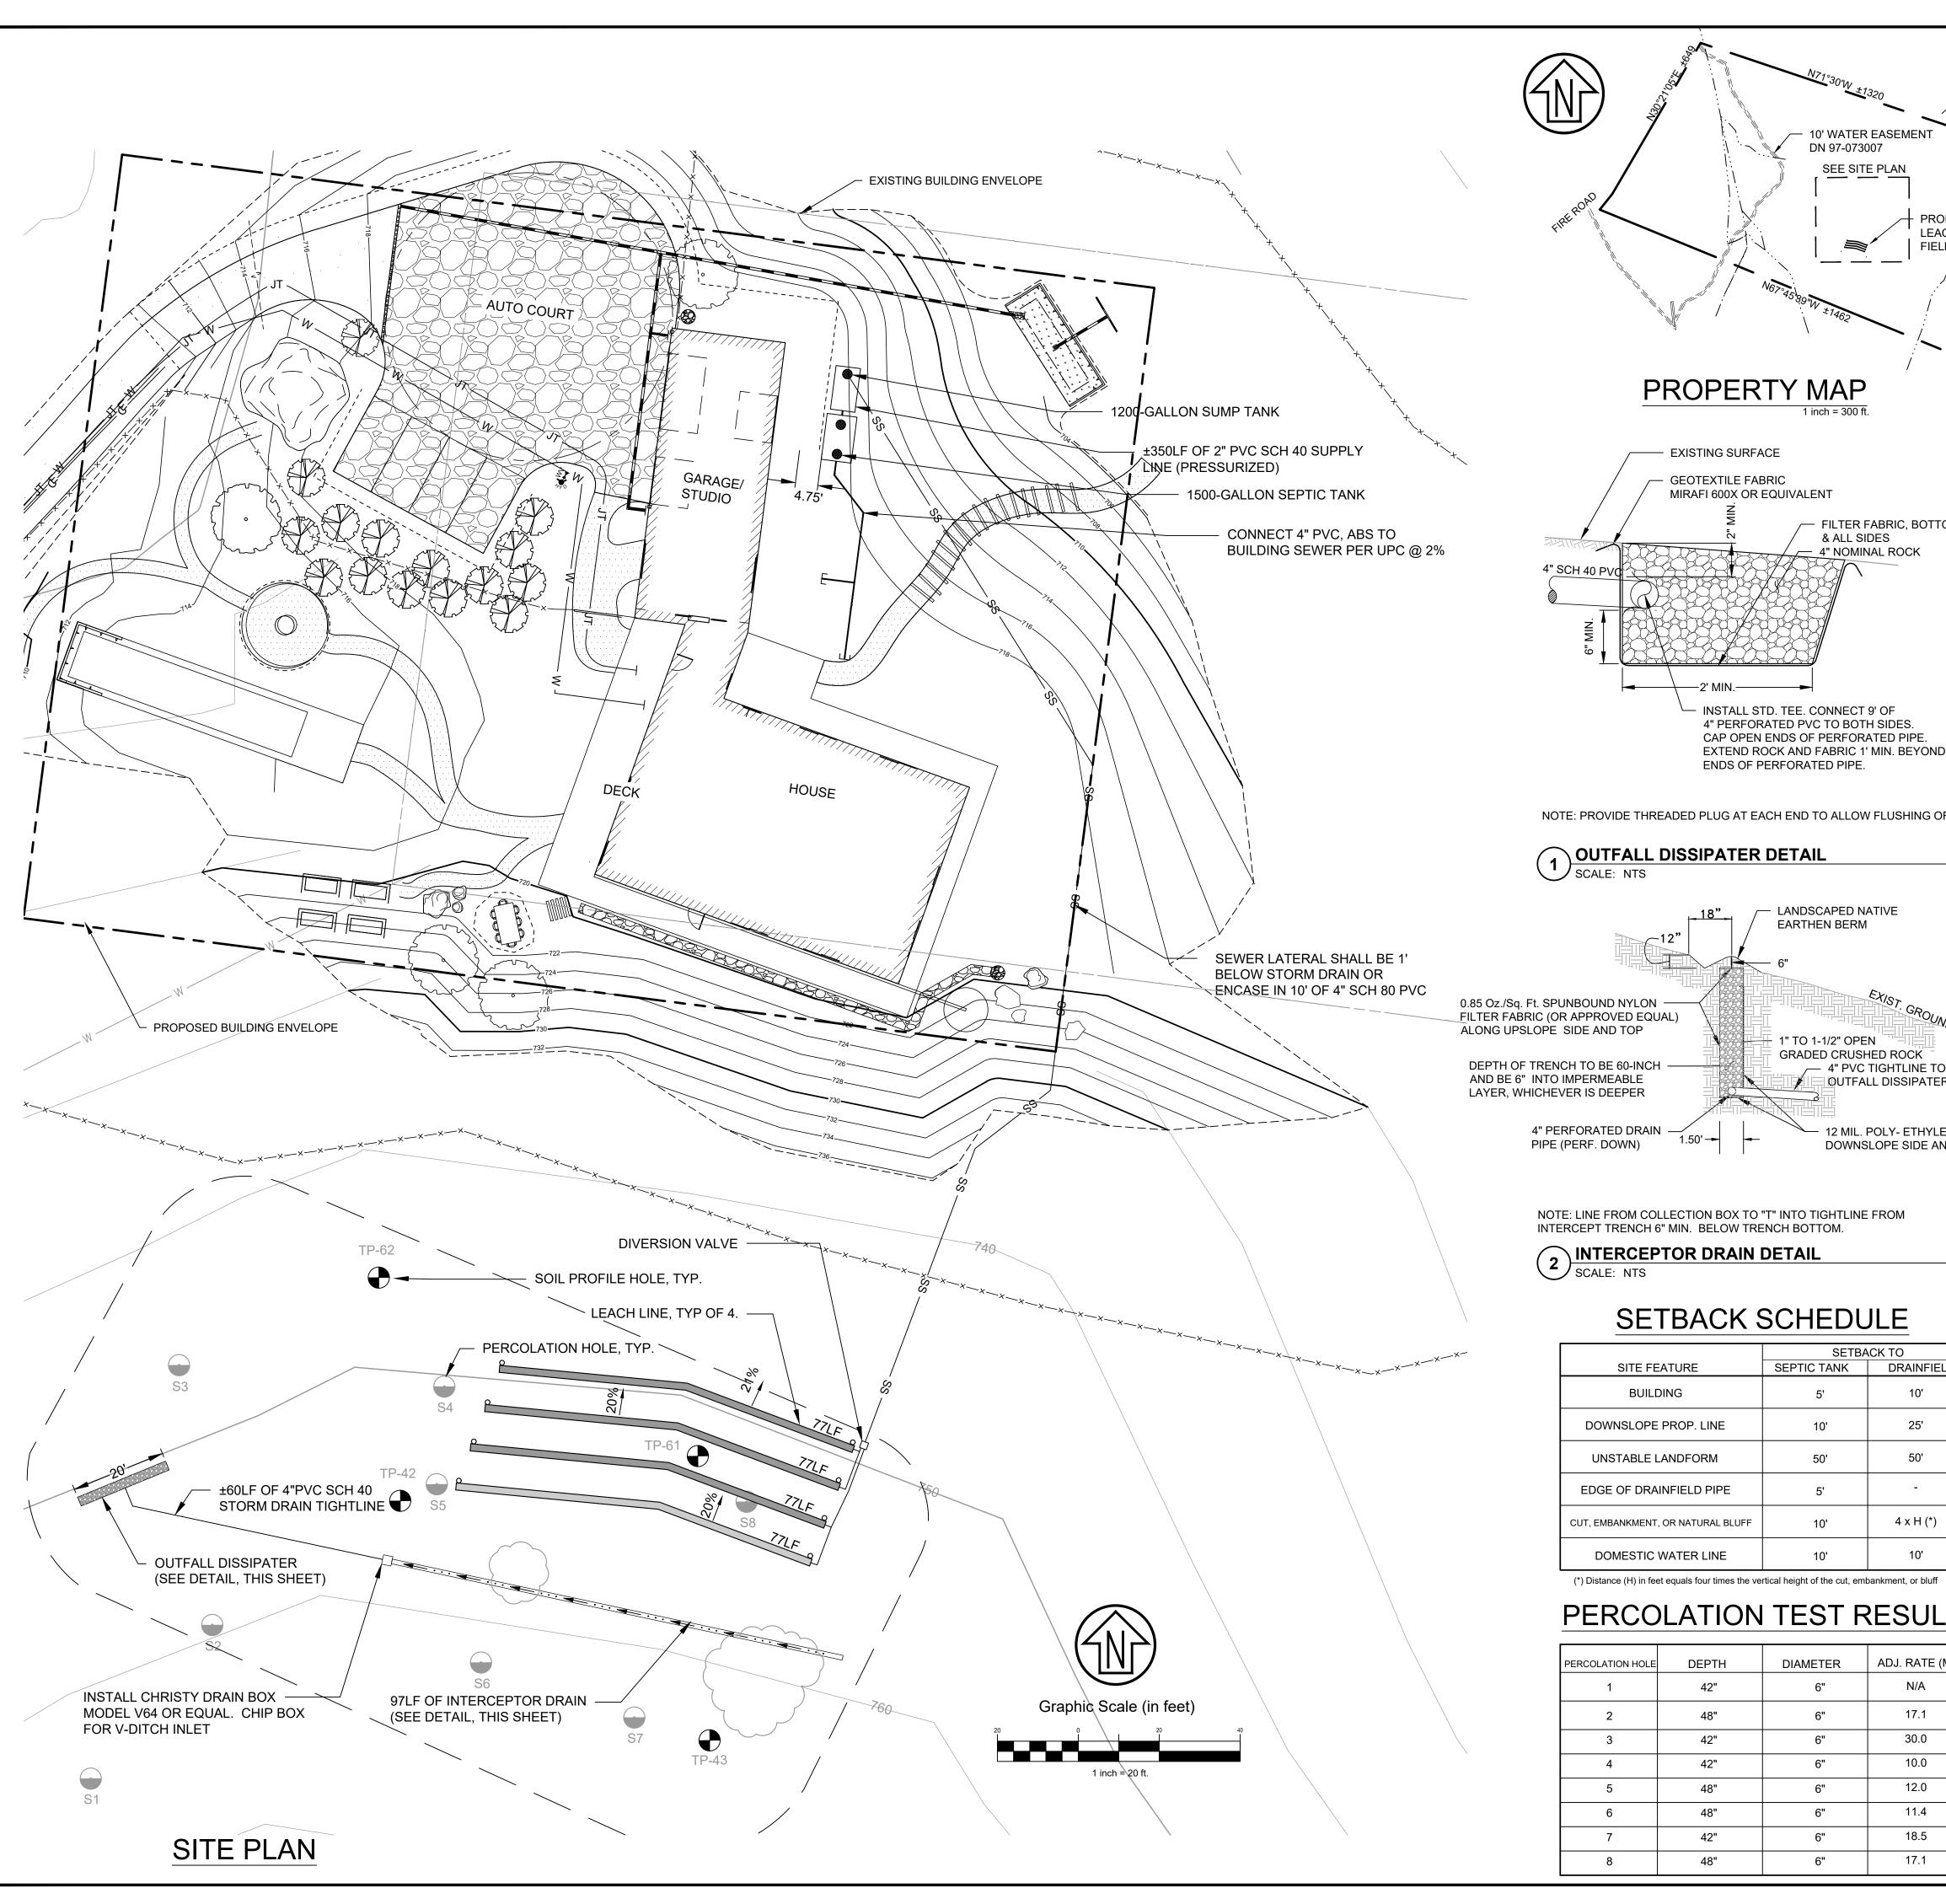
LIMITS OF GRADING & CONSTROCTUION -


Scale: AS SHOWN Date: 08/28/2023 Project Number: 2200248

CMP




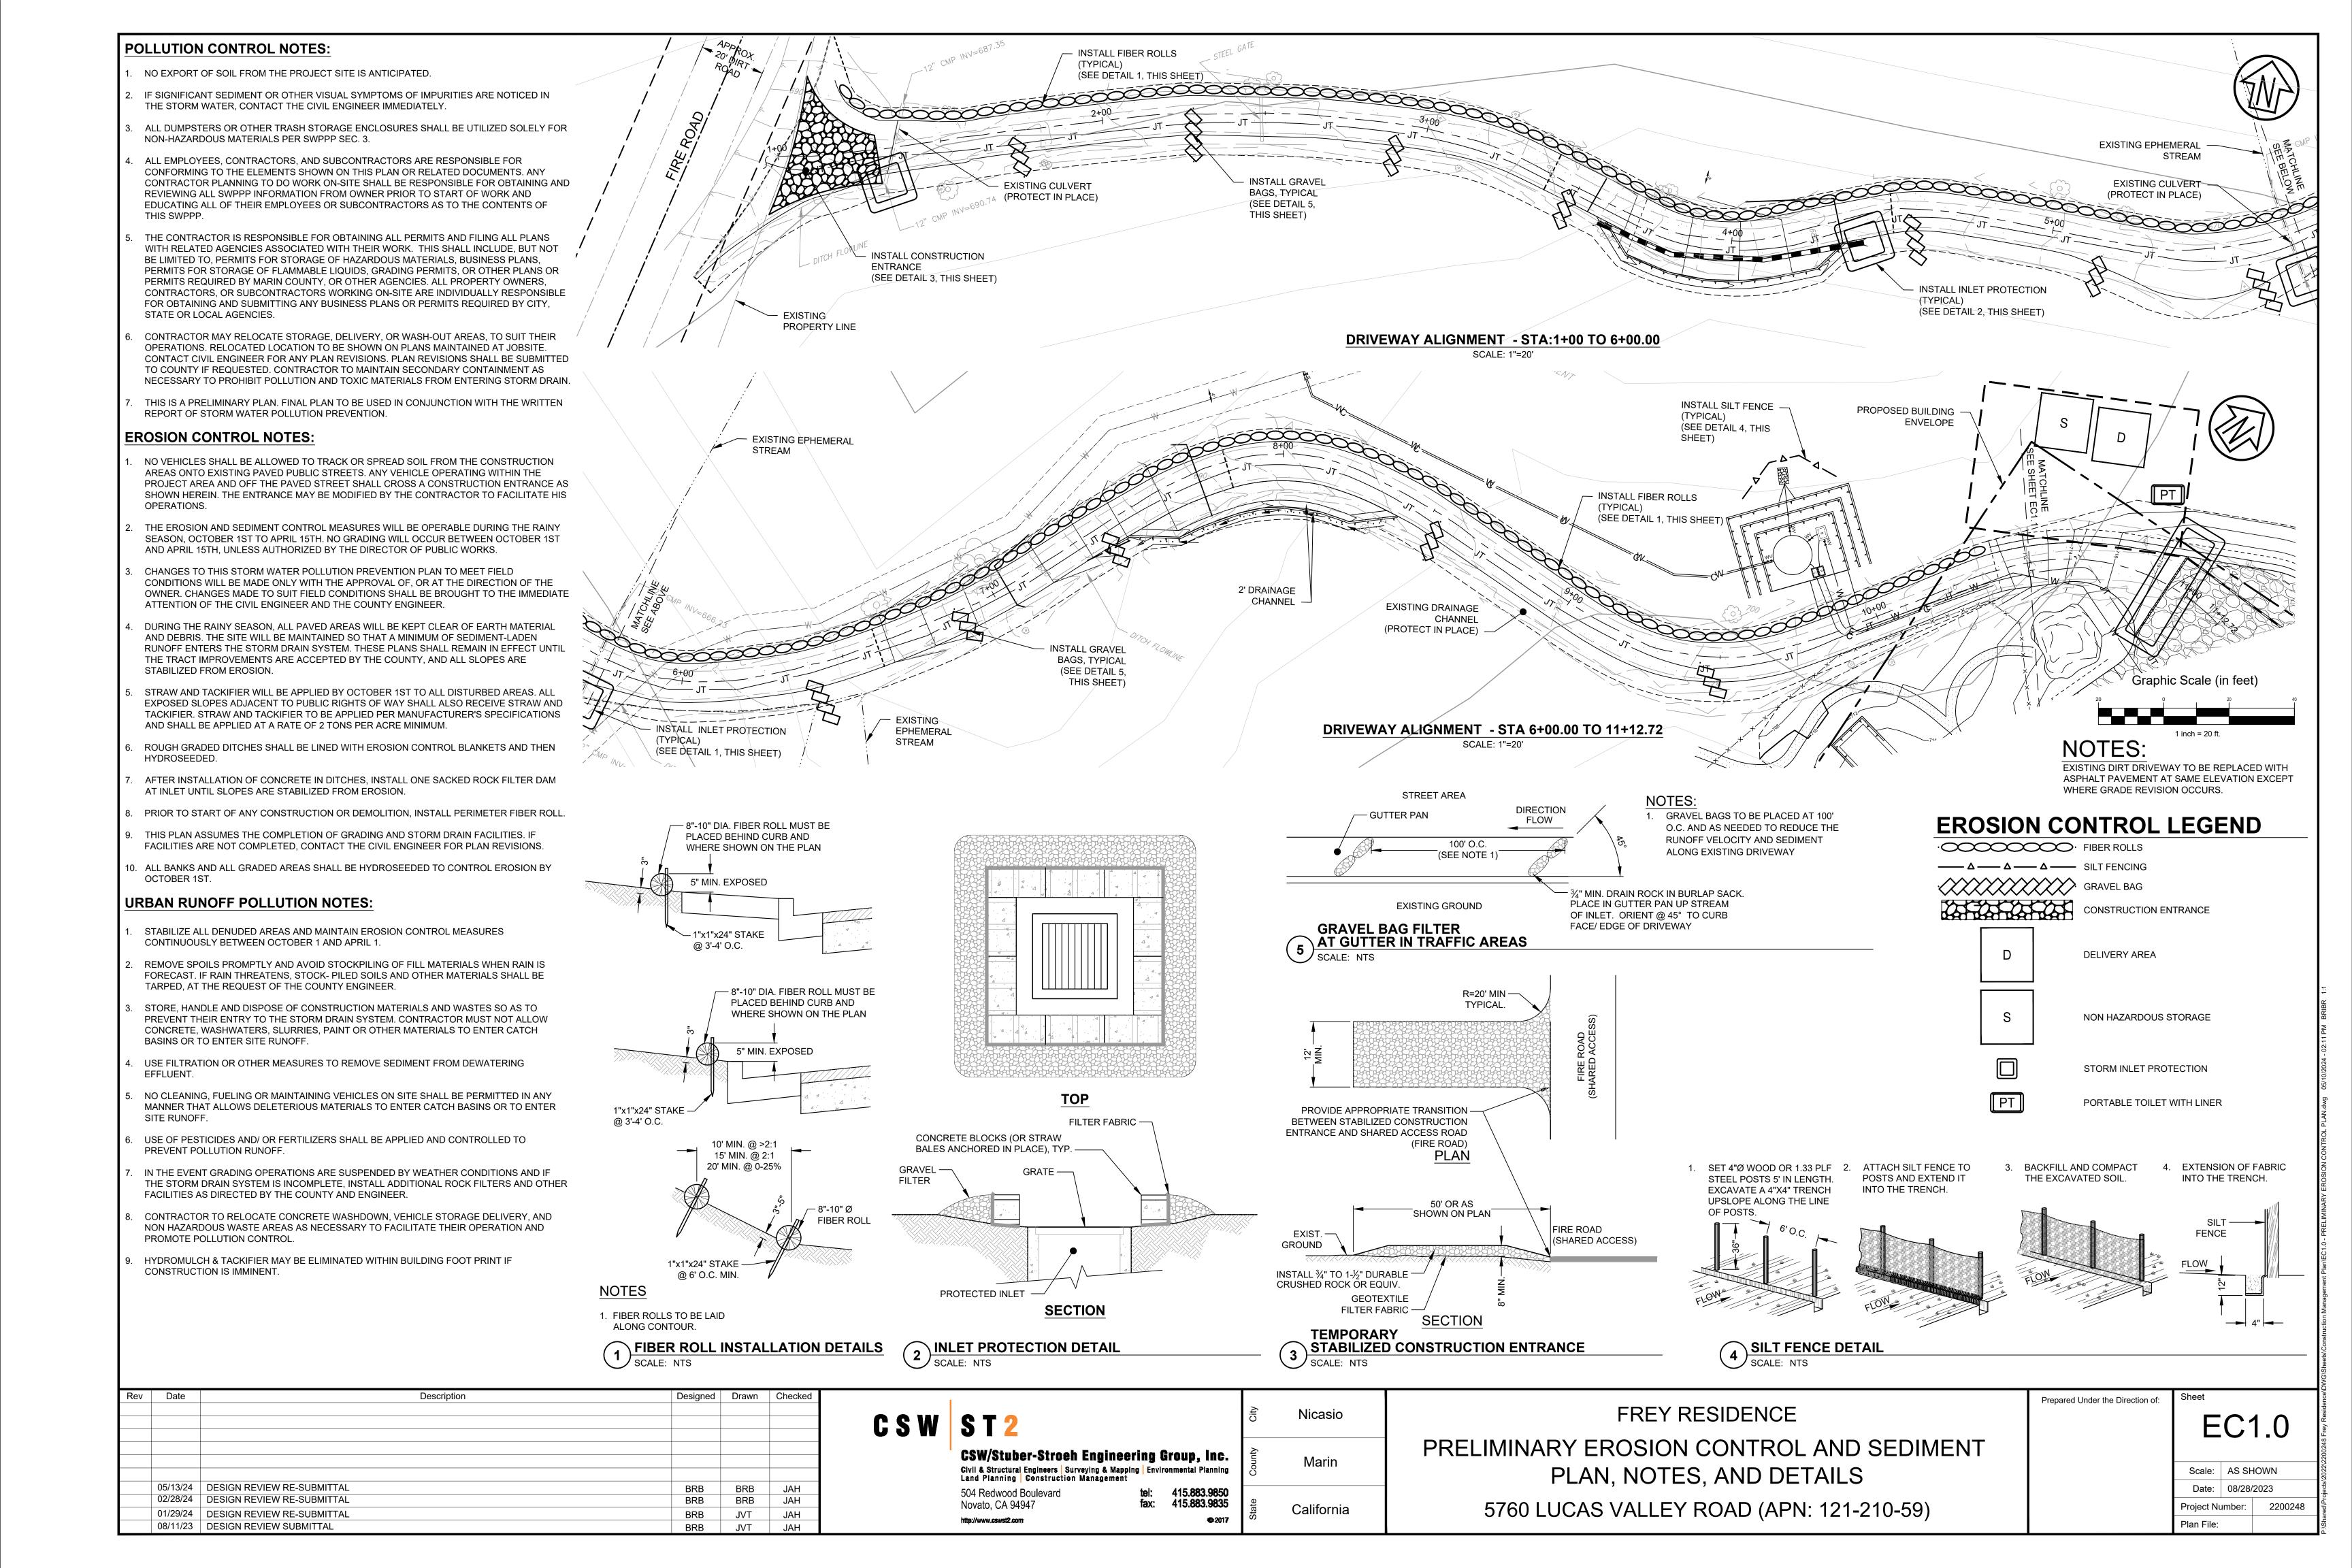

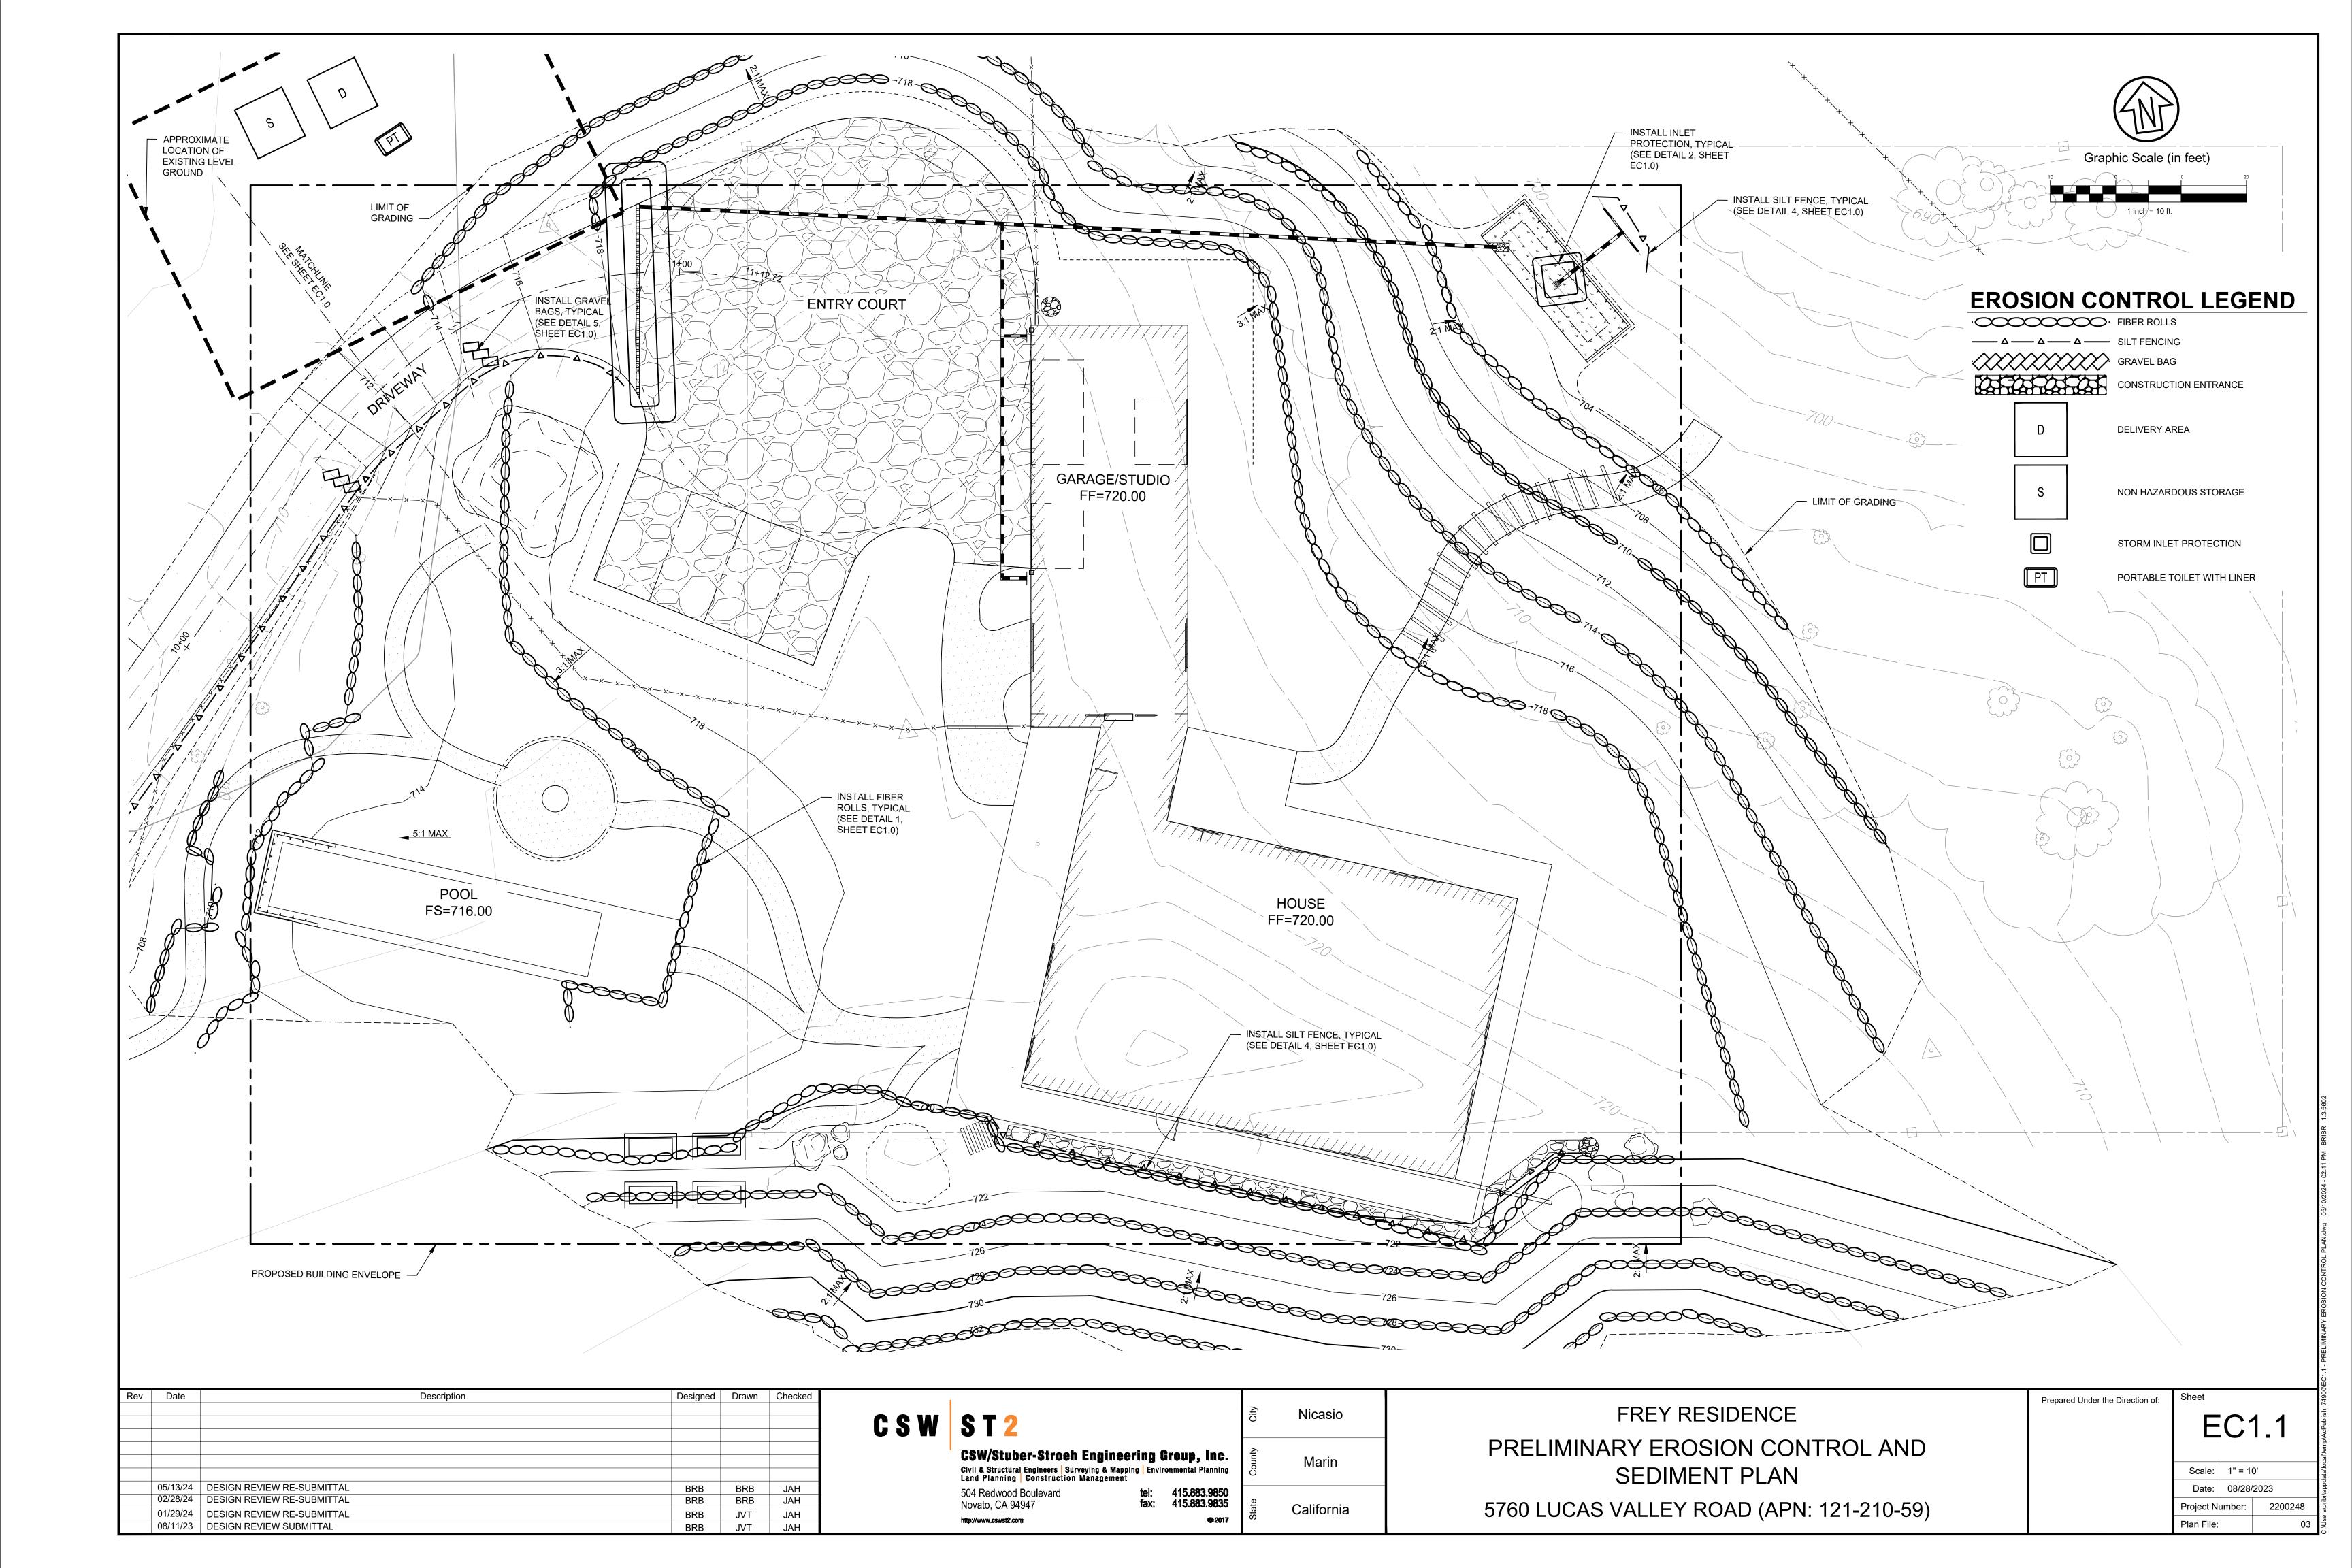

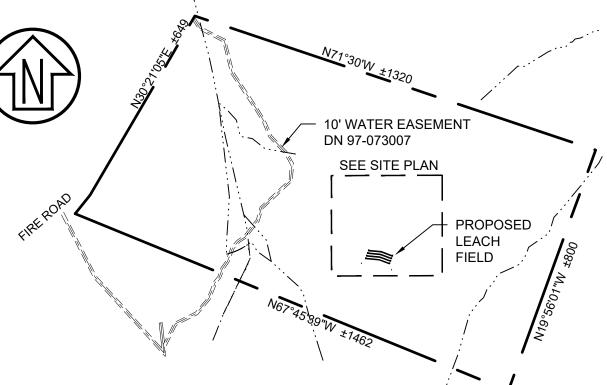

PROPERTY MAP

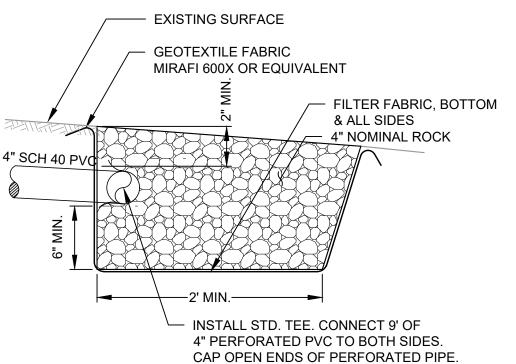


NOTE: PROVIDE THREADED PLUG AT EACH END TO ALLOW FLUSHING OF DEBRIS.

ENDS OF PERFORATED PIPE.

EXTEND ROCK AND FABRIC 1' MIN. BEYOND

OUTFALL DISSIPATER DETAIL

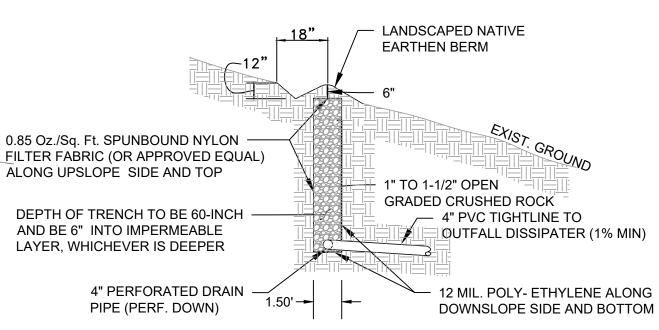

NOTE: LINE FROM COLLECTION BOX TO "T" INTO TIGHTLINE FROM INTERCEPT TRENCH 6" MIN. BELOW TRENCH BOTTOM.


2 INTERCEPTOR DRAIN DETAIL SCALE: NTS

SETBACK SCHEDULE

<u> </u>									
	SETBACK TO								
SITE FEATURE	SEPTIC TANK	DRAINFIELD							
BUILDING	5'	10'							
DOWNSLOPE PROP. LINE	10'	25'							
UNSTABLE LANDFORM	50'	50'							
EDGE OF DRAINFIELD PIPE	5'	-							
CUT, EMBANKMENT, OR NATURAL BLUFF	10'	4 x H (*)							
DOMESTIC WATER LINE	10'	10'							

PERCOLATION TEST RESULTS

PERCOLATION HOLE	DEPTH	DIAMETER	ADJ. RATE (MI
1	42"	6"	N/A
2	48"	6"	17.1
3	42"	6"	30.0
4	42"	6"	10.0
5	48"	6"	12.0
6	48"	6"	11.4
7	42"	6"	18.5
8	48"	6"	17.1

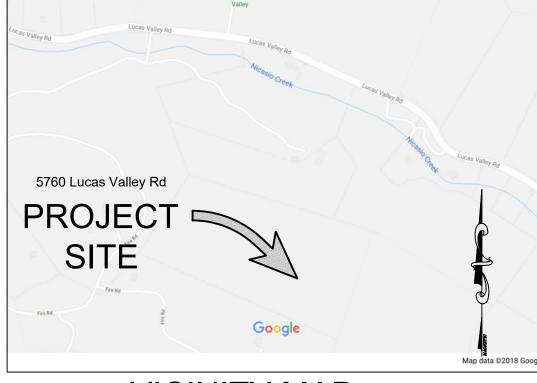

VICINITY MAP

GENERAL SEPTIC NOTES

- 1. This map makes no warranty whatsoever that utilities, either surface or subsurface, do or do not exist. Prior to site planning and/or construction activities, it is recommended that the services of a utility location professional be utilized to ascertain the precise location of any utility, whether shown or not shown hereon.
- 2. Septic improvements shall conform to County setback requirements for a Class I system. Contractor is responsible for verifying property, utilities, and easement line locations prior to construction.
- 3. Future building improvements shall conform to current County septic system

EROSION CONTROL NOTES

- 1. Perform erosion prevention and sediment control in accordance with the latest edition of Appendix Chapter 33 of the California Building Code, applicable County standards, codes and ordinances, and Section 20 of the Caltrans Standard Specifications
- 2. The approved plans shall conform with the erosion prevention and sediment control best management practices contained in the latest editions of the following publications or an equivalent best management

Erosion and Sediment Control Field Manual by the San Francisco Bay Regional Water Quality Control Board. Manual of Standards for Erosion & Sediment Control measures by the Association of Bay Area Governments. Construction site best management practices manual by Caltrans. Stormwater Best Management Practice handbook by the California Stormwater Quality Association.

- 3. If discrepancies occur between these notes, material referenced herein or manufacturer's recommendations, then the most protective shall apply.
- 4. The Owner is responsible for obtaining and complying with the National Pollutant Discharge Elimination System (NPDES) General Permit No. CAS000002 waste discharge requirements for discharges of storm water runoff associated with construction activity disturbing land equal to or greater than once acre. Construction activities include but are not limited to clearing, grading, excavation, stockpiling, and reconstruction of existing facilities involving removal and replacement.
- 5. Preservation of existing vegetation shall occur to the maximum extent practicable.
- 6. The Owner is responsible for preventing storm water pollution generated from the construction site year round. The owner must implement an effective combination of erosion prevention and sediment control on all disturbed areas during the rainy season (October 15 - April 15).
- 7. Erosion prevention and sediment control measures shall be inspected by the owner before and after storms producing at least 1 inch of precipitation in a 24 hour period to ensure measures are functioning properly. Erosion prevention and sediment control measures that have failed or are no longer effective shall be promptly replaced. Erosion prevention and sediment control measures shall be maintained until disturbed areas are stabilized.
- 8. Changes to the erosion prevention and sediment control plan may be made to respond to field conditions. Changes shall be noted on the plan
- 9. Discharges of potential pollutants from construction sites shall be prevented using source controls to the maximum extent practicable. Potential pollutants include but are not limited to: sediment, trash, nutrients, pathogens, petroleum hydrocarbons, metals, concrete, cement, asphalt, lime, paint, stains, glues, wood products, pesticides, herbicides, chemicals, hazardous waste, sanitary waste, vehicle or equipment wash water and chlorinated water.
- 10. Entrance(s) to the construction site shall be maintained in a condition that will prevent tracking or flowing of potential pollutants offsite. Potential pollutants deposited on paved areas within the county right-of-way, such as roadways and sidewalks, shall be properly disposed of at the end of each working day or more frequently as necessary.
- 11. Exposed slopes shall be protected by using erosion prevention measures to the maximim extent practicable, such as establising 70% vegetation coverage, hydroseeding, straw mulch, geotextiles, plastic covers, blankets or mats.
- 12. Whenever it is not possible to utilize erosion prevention measures, exposed slopes shall employ sediment control devices, such as fiber rolls and silt fences, fiber rolls and silt fences shall be trenched and dkeyed into the soil and installed on contour. Silt fences shall be installed approximately 2 to 5 feet from to of slope.
- 13. The Owner shall protect storm drain inlets from potential pollutants until drainage conveyance systems are functional and construction has been completed.
- 14. Energy dissipaters shall be installed at storm drain outlets which have discharge velocities that may contribute to soil erosion.
- 15. Soil and material stockpiles shall be properly protected to minimize sediment and pollutant transport from the construction site.
- 16. Solid waste, such as trash, discarded building materials and debris, shall be placed in designated collection areas or containers. The construction site shall be cleared of solid waste daily, or as necessary, and regular removal and proper disposal shall be arranged.
- 17. Proper application, cleaning and storage of potentially hazardous materials, such as paints and chemicals, shall be conducted to prevent the discharge of pollutants.

CSW ST2

CSW/Stuber-Stroeh Engineering Group, Inc.

45 Leveroni Court tel: 415.883.9850 Novato, CA 94949 fax: 415.883.9835

Civil & Structural Engineers Surveying & Mapping Environmental Planning Land Planning

Construction Management

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<u>B</u> a

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Town Of Nicasio County Of Marin

State Of

California Prepared Under the Direction of:

AS SHOWN Scale:

Date: 08/28/2023 Project Number: 2200248 Plan File:



5760 LUCAS VALLEY ROAD NICASIO, CA 94946

2 12.04.23 Design Review Revisions 12.04.23 Design Review Revisions

PLANT IN WINTER TO TAKE ADVANTAGE OF RAINFALL, IRRIGATE IN

DRY	SEASONS	ONLY

	SYM	QTY	BOTANICAL NAME	COMMON NAME	PLANTING SIZE	MATURE SIZE	PLANT NATIVITY
	DK	1	DORSTENIA FICUS 'BLACK MISSION'	FIG	5 GAL	15'	NON-NATIVE
CxL		- 1	CITRUS X LIMON	LEMON	5 GAL	10'	NON-NATIVE
	CxS	1	CITRUS X SINENSIS	ORANGE	5 GAL	15'	NON-NATIVE
FC		_1	DIOSPYROS KAKI	PERSIMMON	BARE ROOT	20'	NON-NATIVE

PLANT IN WINTER TO TAKE ADVANTAGE OF RAINFALL, NO PARKING AREA SCREENING SHRUBS IRRIGATION, LIMIT TO AREA DISTURBED BY CONSTRUCTION

FANNI	NG AN	LA SCILLINING SIINODS				
SYM	QTY	BOTANICAL NAME	COMMON NAME	PLANTING SIZE	MATURE SIZE	PLANT NATIVITY
	2	HETEROMELES ARBUTIFOLIA	TOYON	1 GAL	15'	MARIN NATIVE
Thursday, and the same of the	Ζ	TILTENOMELES ANDOTH OLIA	TOTON	I GAL	13	MANIN NATIVE
	5	MORELLA CALIFORNICA	CALIFORNIA WAX MYRTLE	1 GAL	15'	MARIN NATIVE

<u>EAST MEADOW</u>

<u>FRUIT TREES</u>

	· · · · ·		
\ \ \		2500SF PERENNIAL AROMATIC MEADOW	PLANT IN WINTER TO TAKE ADVANTAGE OF RAINFALL, NO IRRIGATION, LIMIT TO AREA DISTURBED BY CONSTRUCTION
			The first of the first biological by sometimes and the first biological by the first biological bio

SYM	QTY	BOTANICAL NAME	COMMON NAME	PLANTING SIZE	MATURE SIZE	PLANT NATIVITY
N/A	60	ACHILLEA MILLEFOLIUM	YARROW	4"	1.5'	MARIN NATIVE
N/A	100	FESTUCA CALIFORNICA	CALIFORNIA FESCUE	4"	1'-4'	MARIN NATIVE
N/A	12	LEPECHNIIA	WHITE PITCHER SAGE	4"	5'-8'	MARIN NATIVE
N/A	100	MONARDELLA VILLOSA	COYOTE MINT	4"	2'	MARIN NATIVE
N/A	200	NASELLA PULCHRA	PURPLE NEEDLEGRASS	4"	3.5'	MARIN NATIVE
N/A	15	SALVIA APIANA	WHITE SAGE	4"	5'	SOUTHERN CALIFORNIA N
N/A	1 OZ	SALVIA COLUMBRIAE	CHIA	SEED	1.6'	MARIN NATIVE
N/A	15	SALVIA MELIFERA	BLACK SAGE	4"	6'	CALIFORNIA NATIVE
N/A	120	SALVIA SONOMENSIS	SONOMA SAGE	4"	1.3'	CALIFORNIA NATIVE

12,400SF 6LB EROSION SEED MIX + 4"
PLUGS PLANT IN FALL TO TAKE ADVANTAGE OF RAINFALL, NO IRRIGATION, LIMIT TO AREA DISTURBED BY CONSTRUCTION

_	SYM	QTY	BOTANICAL NAME	COMMON NAME	PLANTING SIZE	MATURE SIZE	PLANT	NATIVITY
	N/A	20%	ACHILLEA MILLEFOLIUM	YARROW	SEED	1.5'	MARIN	NATIVE
	N/A	15%	BROMUS CARINATUS	CALIFORNIA BROME	SEED	5'	MARIN	NATIVE
	N/A	15%	CORETHROGYNE FILAGINIFOLIA	CALIFORNIA ASTER	SEED	3.3'	MARIN	NATIVE
	N/A	15%	ELEYMUS GLAUCUS	BLUE WILDRYE	SEED	5'	MARIN	NATIVE
	N/A	15%	HORDEUM BRACHYANTHERUM	CALIFORNIA MEADOW BARLE	YSEED	3.3'	MARIN	NATIVE
	N/A	20%	NASELLA PULCHRA	PURPLE NEEDLE GRASS	SEED	3.3'	MARIN	NATIVE
	N/A	200	PTERIDIUM AQUILINIFOLIUM	WESTERN BRACKEN FERN	4" PLUG	4'	MARIN	NATIVE
	N/A	200	SISYRINCHIUM BELLUM	BLUE EYED GRASS	4" PLUG	2'	MARIN	NATIVE

EXISTING TREES TO BE REMOVED

SYM	QTY	BOTANICAL NAME	COMMON NAME
	1	QUERCUS AGRIFOLIA	COAST LIVE OAK

TREES TO REPLACE 1 REMOVED

 SYM	QTY	BOTANICAL NAME	COMMON NAME	PLANTING SIZE	MATURE SIZE	PLANT NATIVITY
\	— 3	QUERCUS LOBATA	VALLEY OAK	24" BOX	30-75'	NATIVE

QL

/ <u>IRRIGATION NOTES</u>

PLANTING AND SEEDING TO OCCUR IN FALL AND WINTER

IRRIGATION TO BE INSTALLED FOR FRUIT TREES AND VEGETABLE BEDS ONLY ALL OTHER PLANTS TO RECEIVE WATER VIA PRECIPITATION AND HAND WATERING ONLY



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REV DATE ISSUE 2 12.04.23 Design Review Revisions 3 12.04.23 Design Review Revisions

4 05.13.24 Design Review Revisions


1/16" = 1'

LANDSCAPE PLAN



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1/16" = 1"

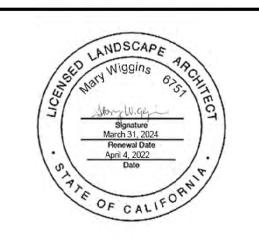

GENERAL NOTES

- A. THERE IS CURRENTLY WOODED AREA CONSISTING OF MATURE QUERCUS AGRIFOLIA, UMBELLULARIA CALIFORNICA, PSEUDOTSUGA MEZEISII, AND A FEW OTHER MISCELLANEOUS TREES. SHRUBS CONSIST MOSTLY OF BACCHARIS PILUARIS. MOST OF THE UNDERSTORY LANDSCAPE ARE NATURALLY GROWING SEASONAL GRASSES AND FERNS.
- 2. <u>PROPOSED SCOPE</u> A. THE INTENT OF THIS PLAN IS TO PROPERLY MAINTAIN THE MATURE TREES WITH SELECTIVE PRUNING AND REMOVAL OF ALL DEAD MATERIAL PER FIREWISE STANDARDS. THE EXISTING SHRUBS
- WILL BE THINNED OR REMOVED TO PROVIDE A FIRE BREAK FROM 0'-30' FROM THE HOME. B. WE PLAN TO REMOVE ANY UMBELLULARIA CALIFORNICA WITHIN THE DEFENSIBLE ZONE, AS IT IS A FIRE PRONE TREE.
- C. WE PLAN TO REMOVE INVSIVE EXOTIC HERBACEOUS PLANTS A ND SHRIUBS WITHIN 30' OF THE HOME.
- 3. <u>FUTURE PLANTING</u>
- A. ANY FUTURE PLANTINGS THROUGHOUT THE SITE WILL INCLUDE FIRE-RESISTANT SHRUBS, PERENNIALS, AND GROUND COVERS AS IN THE FIRESAFE MARIN PLANTING LISTS LOCATED AT WWW.FIRESAFEMARIN.ORG/PLANTS
- 4. LONG TERM MAINTENANCE SCHEDULE AND SAFETY PRACTICES
 - A. ALL FIRE PRONE FUELS AND DEAD MATERIAL WILL BE REMOVED WITHIN 100' OF THE HOME.
 - B. REMOVE BRANCHES BENEATH LARGE TREES FOR A 6-FOOT MINIMUM VERTICAL CLEARANCE.
- C. LIVE PLANTS, BUSHES, SHRUBS, AND TREES SHALL BE MAINTAINED. DEAD VEGETATION AND DEBRIS SHALL BE REMOVED FROM WITHIN AND AROUND THE LIVING PLANT, BUSH, SHRUB, AND/OR
- D. NEEDLES AND LEAVES AND OTHER COMBUSTIBLE DEBRIS AND LITTER SHALL BE REMOVED FROM ROOFS AND GUTTER AT MINIMUM TWICE YEARLY.
- E. ALL WEEDS AND GRASSES SHALL BE CUT REGULARLY TO A HEIGHT OF 4" OR LESS.
- F. VEGETATION SHALL BE TRIMMED TO WITHIN 10' HORIZONTALLY OF ROADWAYS, AND TREES SHALL BE TRIMMED AS NOT TO OVERHANG ROADWAYS AND PROVIDE 14' OF CLEARANCE VERTICALLY.
- G. ALL DEAD AND DYING VEGETATION SHALL BE REMOVED SEASONALLY TO REDUCE VEGETATION VOLUME AND LADDER FUELS.
- H. COORDINATE WITH ADJACENT PROPERTY OWNERS TO MAINTAIN TREE CANOPIES, VEGETATION AND LADDER FUELS ON AN ANNUAL BASIS. I. ALL PLANTINGS SHALL BE SELECTED IN COORDINATION WITH THE FIRESAFE MARIN PLANTING LIST LOCATED AT WWW.FIRESAEMARIN.ORG/PLANTS. OTHER FIRE RESISTANT PLANTS CAN BE UTILIZED WITH PRIOR APPROVAL OF THE FIRE CODE OFFICIAL.
- J. REGARDLESS OF PLANT SELECTION, SHRUBS SHALL BE SPACED SO THAT NO CONTINUITY EXISTS BETWEEN GROUND FUELS AND TREE CROWNS, SUCH THAT A GROUND FIRE WILL NOT EXTEND INTO THE TREE CANOPY.
- VEGETATION AND FUEL MANAGEMENT:
- A VEGETATION MANAGEMENT PLAN IS REQUIRED TO BE SUBMITTED AT THE BUILDING PERMIT PHASE. THE PLAN SHALL BE REVISED TO MEET THE FOLLOWING REQUIREMENTS:
- I. INDIVIDUAL SHRUB SPACING IS REQUIRED TO BE PROVIDED WITHIN 30 FEET OF ANY STRUCTURE. SHRUBS SHALL BE SEPARATED BY AT LEAST ONE TIME THE HEIGHT OF THE MATURE
- II. FOUNTAIN GRASSES SHALL BE REMOVED WITHIN 30 FEET OF ANY STRUCTURE AND REPLACED WITH A SPECIES WITH FIRE RESISTIVE QUALITIES. B. A VERTICAL OVERHEAD CLEARANCE OF 13' 6" SHALL BE MAINTAINED FREE OF OBSTRUCTIONS ABOVE ANY ROADBED (TREES, BRUSH, ETC.).
- I. THE PROPERTY OWNER SHALL COMPLY WITH CALIFORNIA FIRE CODE SECTION 304.1.2 AND LOCAL ORDINANCE SECTION 110.4.2 ABATEMENT OF CLEARANCE OF FLAMMABLE BRUSH OR
- FLAMMABLE VEGETATIVE GROWTH FROM STRUCTURES. II. A MINIMUM CLEARANCE OF 30 FEET FROM THE STRUCTURE OR TO THE PROPERTY LINE, 10 FEET FROM ROADS AND PROPERTY LINES AND ANY TREE WHICH EXTENDS WITHIN 10 FEET
- OF ANY CHIMNEY OR STOVEPIPE SHALL BE KEPT CLEAR OF FLAMMABLE BRUSH. TREE LIMBS AND GRASSES. III. EXCEPTION: VEGETATION MANAGEMENT PLAN FOR THE PROPERTY HAS BEEN SUBMITTED AND APPROVED BY THE FIRE CODE OFFICIAL.
- C. THE APPLICANT SHALL COMPLY WITH CALIFORNIA FIRE CODE AND PUBLIC RESOURCE CODE 4291 REQUIREMENTS RELATING TO THE CLEARANCE OF FLAMMABLE BRUSH AND WEEDS. A MINIMUM CLEARANCE OF 30' FROM STRUCTURES AND 10' FROM ROADS AND PROPERTY LINES SHALL BE MAINTAINED. WILDLAND URBAN INTERFACE VEGETATION REQUIREMENTS: ANY PERSON WHO OWNS, LEASES, CONTROLS OR MAINTAINS ANY BUILDING OR STRUCTURE, VACANT LANDS, OPEN SPACE, AND/OR
- LANDS WITHIN SPECIFIC WILDLAND URBAN INTERFACE AREAS OF THE JURISDICTION OF THE SOUTHERN MARIN FIRE PROTECTION DISTRICT, SHALL COMPLY WITH THE FOLLOWING: I. CUT AND REMOVE ALL FIRE PRONE VEGETATION WITHIN 30 FEET OF STRUCTURES, UP TO 150 FEET WHEN TOPOGRAPHIC OR COMBUSTIBLE VEGETATIVE TYPES NECESSITATE REMOVAL AS DETERMINED BY THE FIRE CODE OFFICIAL.
- II. REMOVE ACCUMULATED DEAD VEGETATION ON THE PROPERTY.
 - III. CUT AND REMOVE TREE LIMBS THAT OVERHANG WOOD DECKS AND ROOFS.
 - IV. REMOVE THAT PORTION OF ANY TREE WHICH EXTENDS WITHIN 10 FEET OF ANY CHIMNEY OR STOVEPIPE, ROOF SURFACES AND ROOF GUTTERS
- V. CLEAN ANY LEAVES AND NEEDLES FROM ROOF AND GUTTERS.
- VI. CUT AND REMOVE GROWTH LESS THAN 3-INCHES IN DIAMETER, FROM THE GROUND UP TO A MAXIMUM HEIGHT OF 10 FEET, PROVIDED THAT NO CROWN SHALL BE RAISED TO A POINT SO AS TO REMOVE BRANCHES FROM MORE THAN THE LOWER ONE-THIRD OF THE TREE'S TOTAL HEIGHT.
- VII. VEGETATION CLEARANCE REQUIREMENTS FOR NEW CONSTRUCTION AND SUBSTANTIAL REMODELS IN WILDLAND-URBAN INTERFACE AREAS SHALL BE IN ACCORDANCE WITH THE 2018 INTERNATIONAL WILDLAND-URBAN INTERFACE CODE, AS AMENDED BY THE SOUTHERN MARIN FIRE PROTECTION DISTRICT
- VIII. CLEARANCE OF FLAMMABLE BRUSH OR VEGETATIVE GROWTH FROM FIRE ACCESS ROAD OR DRIVEWAYS. THE FIRE CODE OFFICIAL IS AUTHORIZED TO REQUIRE, WITHIN 10 FEET ON EACH SIDE AND 15 FEET IN HEIGHT OF HIGHWAYS, STREETS, FIRE APPARATUS ROADS AND DRIVEWAYS, TO BE ABATED OF FLAMMABLE VEGETATION AND OTHER COMBUSTIBLE GROWTH.
- EXCEPTION 1: WHEN APPROVED BY THE FIRE CODE OFFICIAL, SINGLE SPECIMENS OF TREES, ORNAMENTAL SHRUBBERY OR SIMILAR PLANTS, OR PLANTS USED AS GROUND COVERS. PROVIDED THEY DO NOT FORM A MEANS OF RAPIDLY TRANSMITTING FIRE FROM THE NATIVE GROWTH TO ANY STRUCTURE.
- EXCEPTION 2: WHEN APPROVED BY THE FIRE CODE OFFICIAL, GRASS AND OTHER VEGETATION LOCATED MORE THAN 30 FEET (9144 MM) FROM BUILDINGS OR STRUCTURES LESS THAN 18 INCHES (457 MM) IN HEIGHT ABOVE THE GROUND NEED NOT BE REMOVED WHERE NECESSARY TO STABILIZE SOIL AND PREVENT EROSION.

HAZARD ZONES

IMMEDIATE ZONE (ZONE 0): 0'-5'

THE IMMEDIATE ZONE EXTENDS 0-5' FROM THE HOUSE. ZONE O IS THE AREA CLOSEST TO THE HOUSE, INCLUDING THE STRUCTURE ITSELF, DECKS, OUTDOOR FURNITURE, AND THE OUTSIDE WALLS AND COVERINGS. THIS AREA IS MOST VULNERABLE, AND SHOULD BE MOST AGGRESSIVELY MAINTAINED FOR FIRE RESISTANCE.

- REMOVE ANY COMBUSTIBLE OUTDOOR FURNITURE. REPLACE JUTE OR FIBER DOOR MATS WITH FIRE RESISTANT MATERIALS.
- REMOVE OR RELOCATE ALL COMBUSTIBLE MATERIALS, INCLUDING GARBAGE AND RECYCLING CONTAINERS, LUMBER, TRASH, AND PATIO ACCESSORIES.
- CLEAN ALL FALLEN LEAVES AND NEEDLES REGULARLY. REPEAT OFTEN DURING FIRE SEASON.
- NO VEGETATION IS RECOMMENDED WITHIN 5' OF STRUCTURES.
- REMOVE TREE LIMBS THAT EXTEND INTO THIS ZONE. FIRE-PRONE TREE VARIETIES SHOULD BE REMOVED IF THEY EXTEND WITHIN 5' OF STRUCTURES...
- DO NOT STORE FIREWOOD, LUMBER, OR COMBUSTIBLES HERE, EVEN (ESPECIALLY) UNDER DECKS OR OVERHANGS. MOVE
- STORED COMBUSTIBLES INSIDE. OR AT LEAST 30' AWAY FROM STRUCTURES. USE ONLY INORGANIC, NON-COMBUSTIBLE MULCHES SUCH AS STONE OR GRAVEL.

INTERMEDIATE ZONE (ZONE 1): 5'-30'

THE INTERMEDIATE ZONE FROM 5' TO 30' OUT FROM BUILDINGS, STRUCTURES, DECKS, ETC. KEEP ZONE 1 "LEAN, CLEAN, AND GREEN" AND EMPLOY CAREFUL LANDSCAPING TO CREATE BREAKS THAT CAN HELP INFLUENCE AND DECREASE FIRE BEHAVIOR.

- REMOVE ALL DEAD PLANTS, GRASS, AND WEEDS (VEGETATION).
- REMOVE DEAD OR DRY LEAVES AND PINE NEEDLES FROM YOUR YARD, ROOF AND RAIN GUTTERS.
- TRIM TREES REGULARLY TO KEEP BRANCHES A MINIMUM OF 10 FEET FROM OTHER TREES.
- REMOVE BRANCHES THAT HANG OVER YOUR ROOF AND KEEP DEAD BRANCHES 10 FEET AWAY FROM YOUR CHIMNEY.
- REMOVE VEGETATION AND ITEMS THAT COULD CATCH FIRE FROM AROUND AND UNDER DECKS.
- REMOVE FIRE-PRONE PLANTS, AND CHOOSE ONLY FIRE-RESISTANT VARIETIES. IRRIGATE REGULARLY.
- REMOVE LIMBS TO A HEIGHT OF 10' ABOVE THE GROUND (OR 1/3 THE HEIGHT OF THE TREE) TO PROVIDE CLEARANCE AND TO ELIMINATE A "FIRE LADDER".
- USE ONLY INORGANIC, NON-COMBUSTIBLE MULCHES SUCH AS STONE OR GRAVEL. COMPOSTED MULCH AND LARGE BARK AND CHIPS (GREATER THAN 1/2" DIAMETER) MAY BE OK.

EXTENDED ZONE (ZONE 2): 30'-100'

THE EXTENDED ZONE FROM 30' TO 100' (OR MORE, IF REQUIRED DUE TO STEEP SLOPES, NEARBY VEGETATION CONDITIONS, AND/OR YOUR LOCAL FIRE DEPARTMENT). THE GOAL HERE IS NOT TO ELIMINATE FIRE BUT TO INTERRUPT FIRE'S PATH AND KEEP FLAMES SMALLER AND ON THE GROUND. THIS ZONE SHOULD INCLUDE AT A MINIMUM:

- CUT OR MOW ANNUAL GRASS DOWN TO A MAXIMUM HEIGHT OF 4 INCHES.
- CREATE HORIZONTAL SPACING BETWEEN SHRUBS. TREES AND VERTICAL SPACING BETWEEN GRASS. SHRUBS AND TREES. REMOVE FALLEN LEAVES. NEEDLES, TWIGS. BARK. CONES. AND SMALL BRANCHES. HOWEVER. THEY MAY BE PERMITTED TO A
- DEPTH OF 3 INCHES IF EROSION CONTROL IS AN ISSUE.

ACCESS ZONE (ZONE 3): 14' FROM DRIVEWAYS AND ROADS

- THE ACCESS ZONE 10' FROM DRIVEWAYS AND ROADS. THIS ZONE SHOULD INCLUDE AT A MINIMUM:
- CLEAR VEGETATION 14' OVERHEAD AND 10: FROM SIDES OF ROADS AND DRIVEWAYS IN THE SAME MANNER AS DEFIENSIBLE SPACE ZONE 1.
- MAINTAIN 12' UNOBSTRUCTED PAVEMENT FOR PASSAGE OF VEHICLES
- PLANTINGS ARE TO BE FIRE RESISTANT AND NOT EXTEND INTO ROADWAY
- ADDRESS NUMBERS ARE TO BE 4" MINIMUM AND ARE VISIBLE FROM ROADWAYS
- 14' CLEARANCE ABOVE ROADWAY FOR EMERGENCY VEHICLE ACCESS
- CREATE VERTICAL SPACING BETWEEN SHRUBS AND TREES. CUT ALL GRASSES.

PRESERVATION AND REPLACEMENT ZONE (ZONE 4): REMAIINDER OF PREPERTY OUTSIDE OF ZONES 1-3

STANDS OF TREES ARE PRESERVED AND REPLACED AS REQUIRED

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